

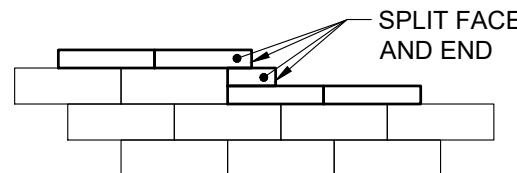


CAP UNIT

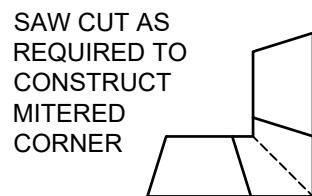

WALL FACE

1. ALWAYS START CAPPING WALL FROM THE LOWEST ELEVATION.
2. LAYOUT CAPS PRIOR TO USING ADHESIVE.
3. CUT CAPS TO FIT. VARIOUS COMBINATIONS OF LONG AND SHORT CAP FACES WILL BE NECESSARY FOR RADII GREATER THAN THE MINIMUM.
4. ALTERNATE SHORT AND LONG CAP FACES EVERY OTHER CAP TO ACHIEVE A STRAIGHT ROW OF CAPS.
5. USE EXTERIOR-GRADE CONSTRUCTION ADHESIVE TO SECURE CAPS.

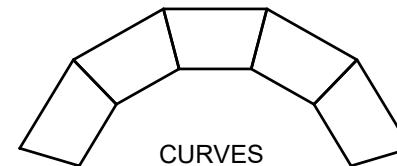


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**Diamond® 10D Retaining Wall System**  
**TYPICAL CAPPING DETAILS**

Scale: NONE	Drawn by: MAH
Date: 10/29/2025	Drawing number: D10D-01



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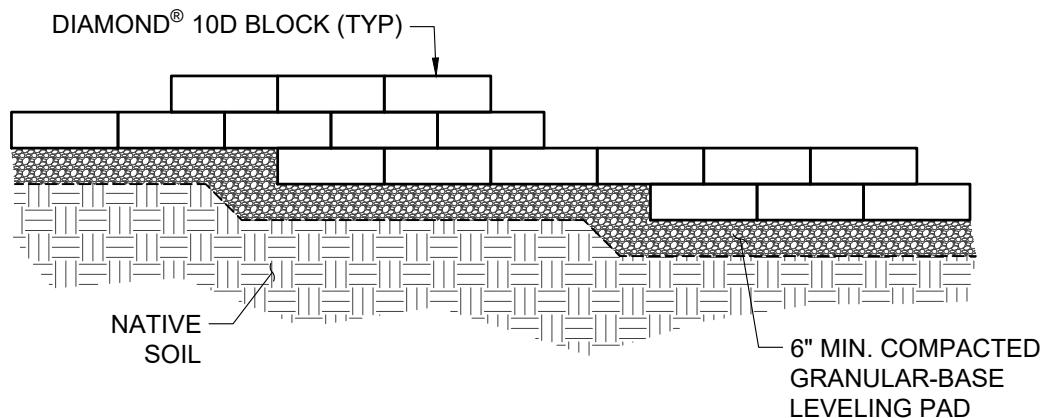
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## Diamond® 10D Retaining Wall System

### TYPICAL BASE PREPARATION

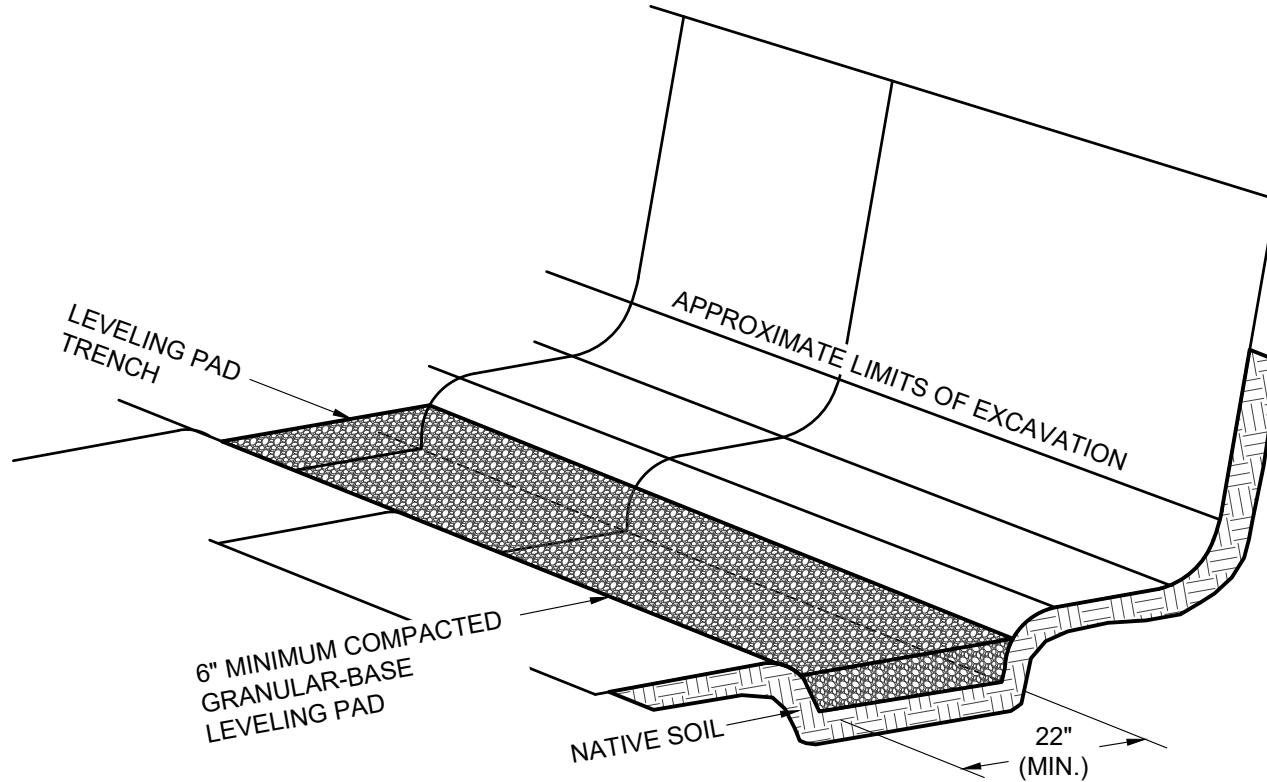Scale:	NONE	Drawn by:	MAH
Date:	10/29/2025	Drawing number:	D10D-02



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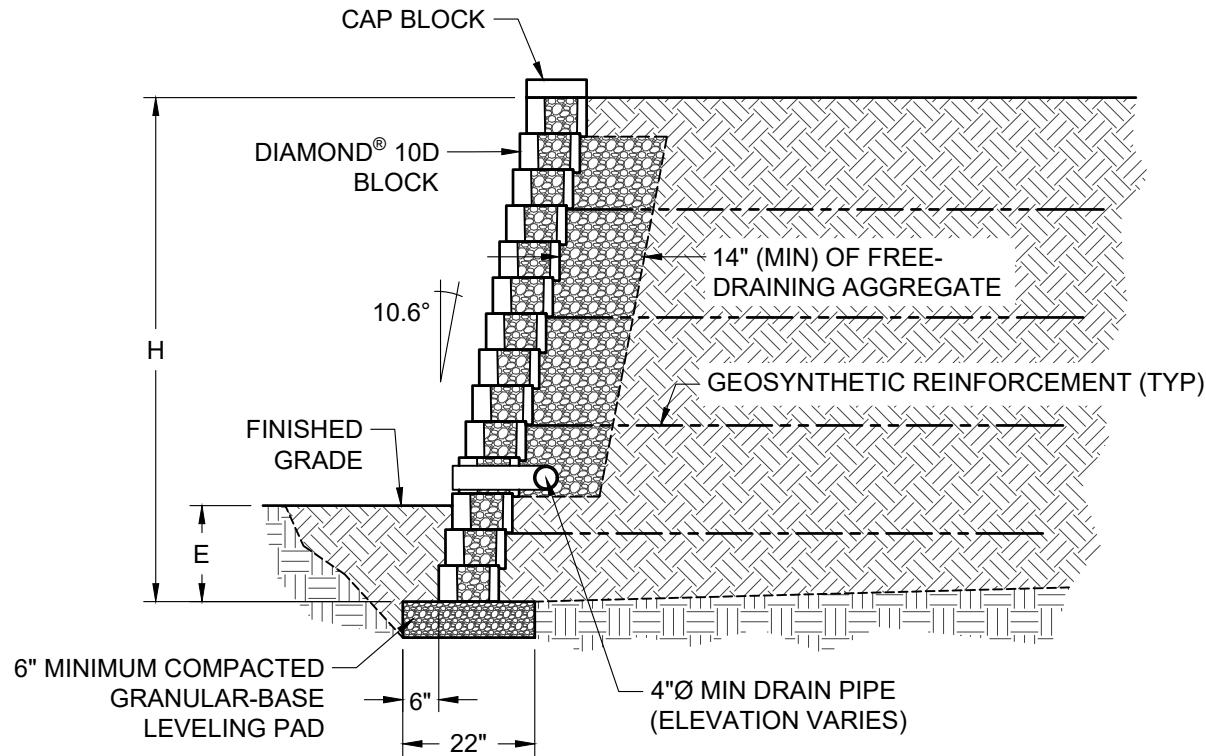
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## Diamond® 10D Retaining Wall System

### TYPICAL BASE STEP-UP

Scale: 3/8" = 1'-0"	Drawn by: MAH
Date: 10/29/2025	Drawing number: D10D-03



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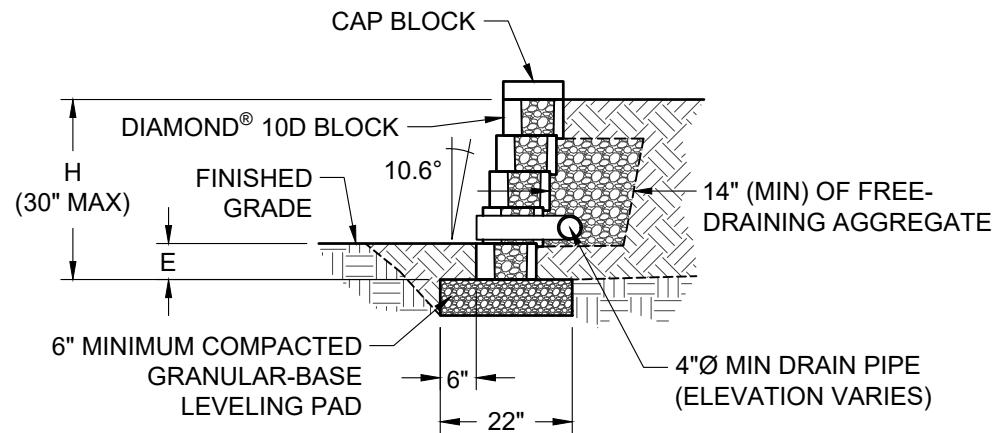
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## Diamond® 10D Retaining Wall System

### TYPICAL REINFORCED CROSS SECTION

Scale: 3/8" = 1'-0"	Drawn by: MAH
Date: 10/29/2025	Drawing number: D10D-04



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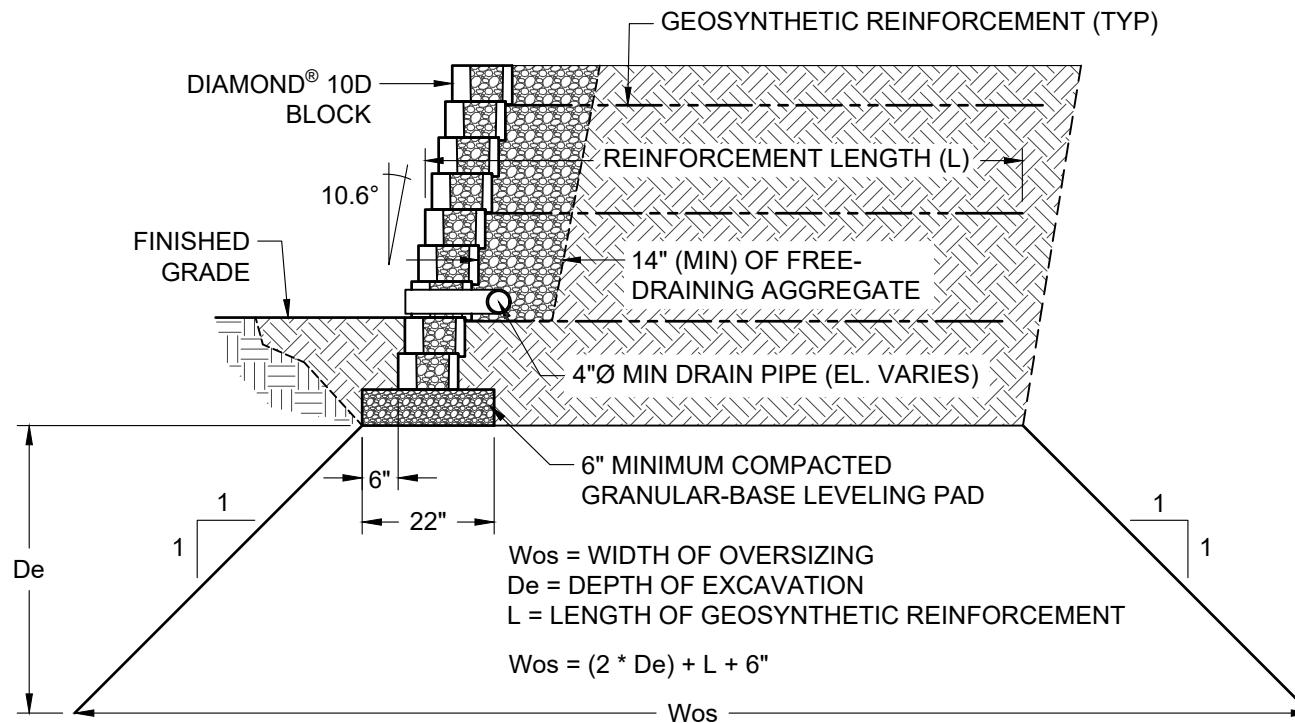
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## Diamond® 10D Retaining Wall System

### TYPICAL GRAVITY CROSS SECTION

Scale: 3/8" = 1'-0"	Drawn by: MAH
Date: 10/29/2025	Drawing number: D10D-05



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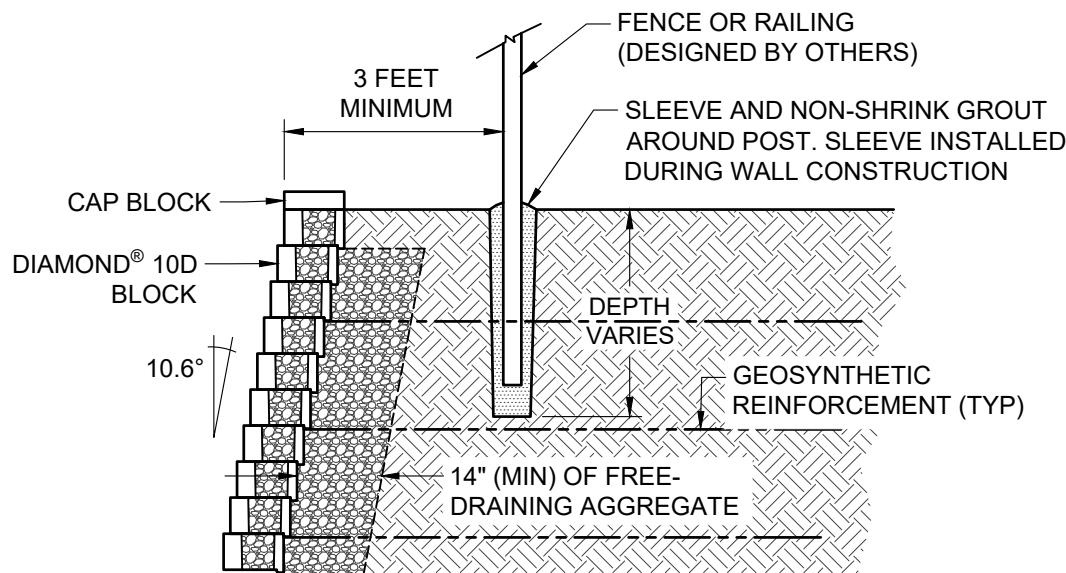
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## Diamond® 10D Retaining Wall System

### TYPICAL EXCAVATION OVERRSIZING

Scale: 3/8" = 1'-0"	Drawn by: MAH
Date: 10/29/2025	Drawing number: D10D-06



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## Diamond® 10D Retaining Wall System

### TYPICAL FENCE CROSS SECTION


Scale: 3/8" = 1'-0"	Drawn by: MAH
Date: 10/29/2025	Drawing number: D10D-07

NOTES:

THE USE OF TOPGUIDE™ IS LIMITED TO HANDRAIL AND SAFETY RAIL APPLICATIONS PER IBC 1607.8.1

THE TOPGUIDE™ PRODUCT SHALL BE EVENLY SPACED. USE OF THE TOPGUIDE™ SYSTEM IS LIMITED TO THE FOLLOWING FENCING APPLICATIONS WITHOUT CONSIDERATION OF WIND LOAD:

- 8-FOOT HIGH AND UNDER CHAIN LINK FENCES
- 6-FOOT HIGH AND UNDER WOOD FENCES WITH GAPS BETWEEN BOARDS
- 6-FOOT HIGH AND UNDER PVC, STEEL, ALUMINUM, OR WROUGHT IRON FENCES

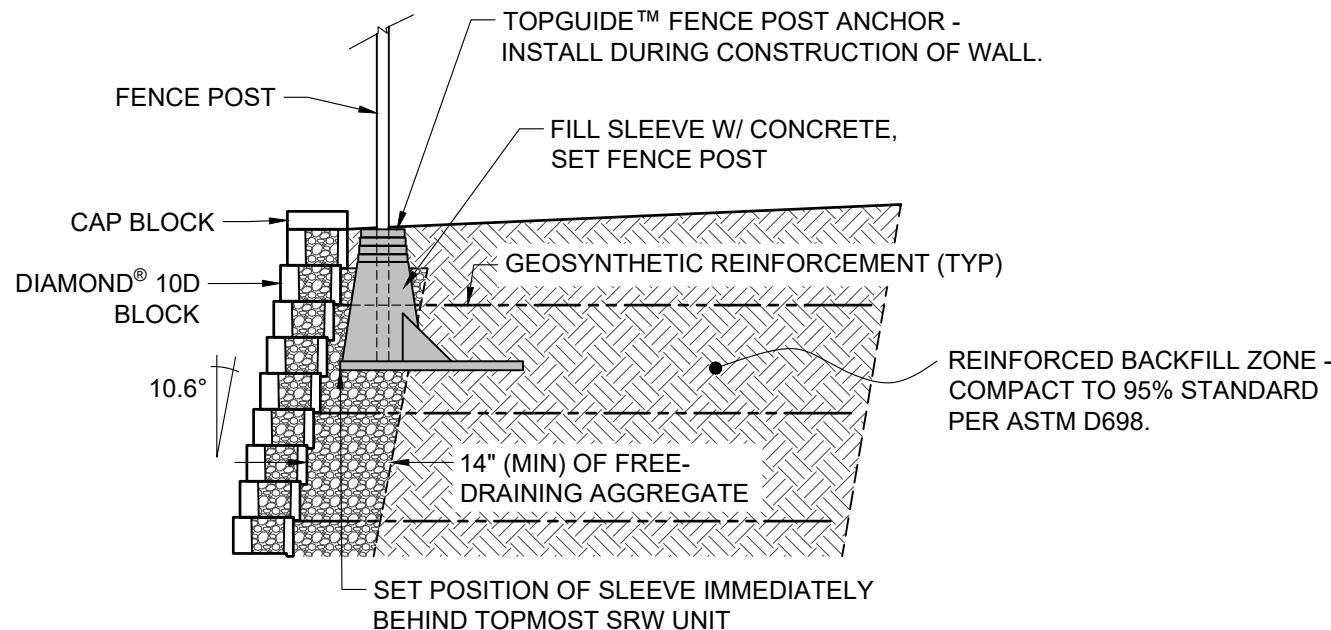


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**Diamond® 10D Retaining Wall System**  
**ALTERNATE FENCE CROSS SECTION**

Scale: 3/8" = 1'-0"	Drawn by: MAH
Date: 10/29/2025	Drawing number: D10D-08



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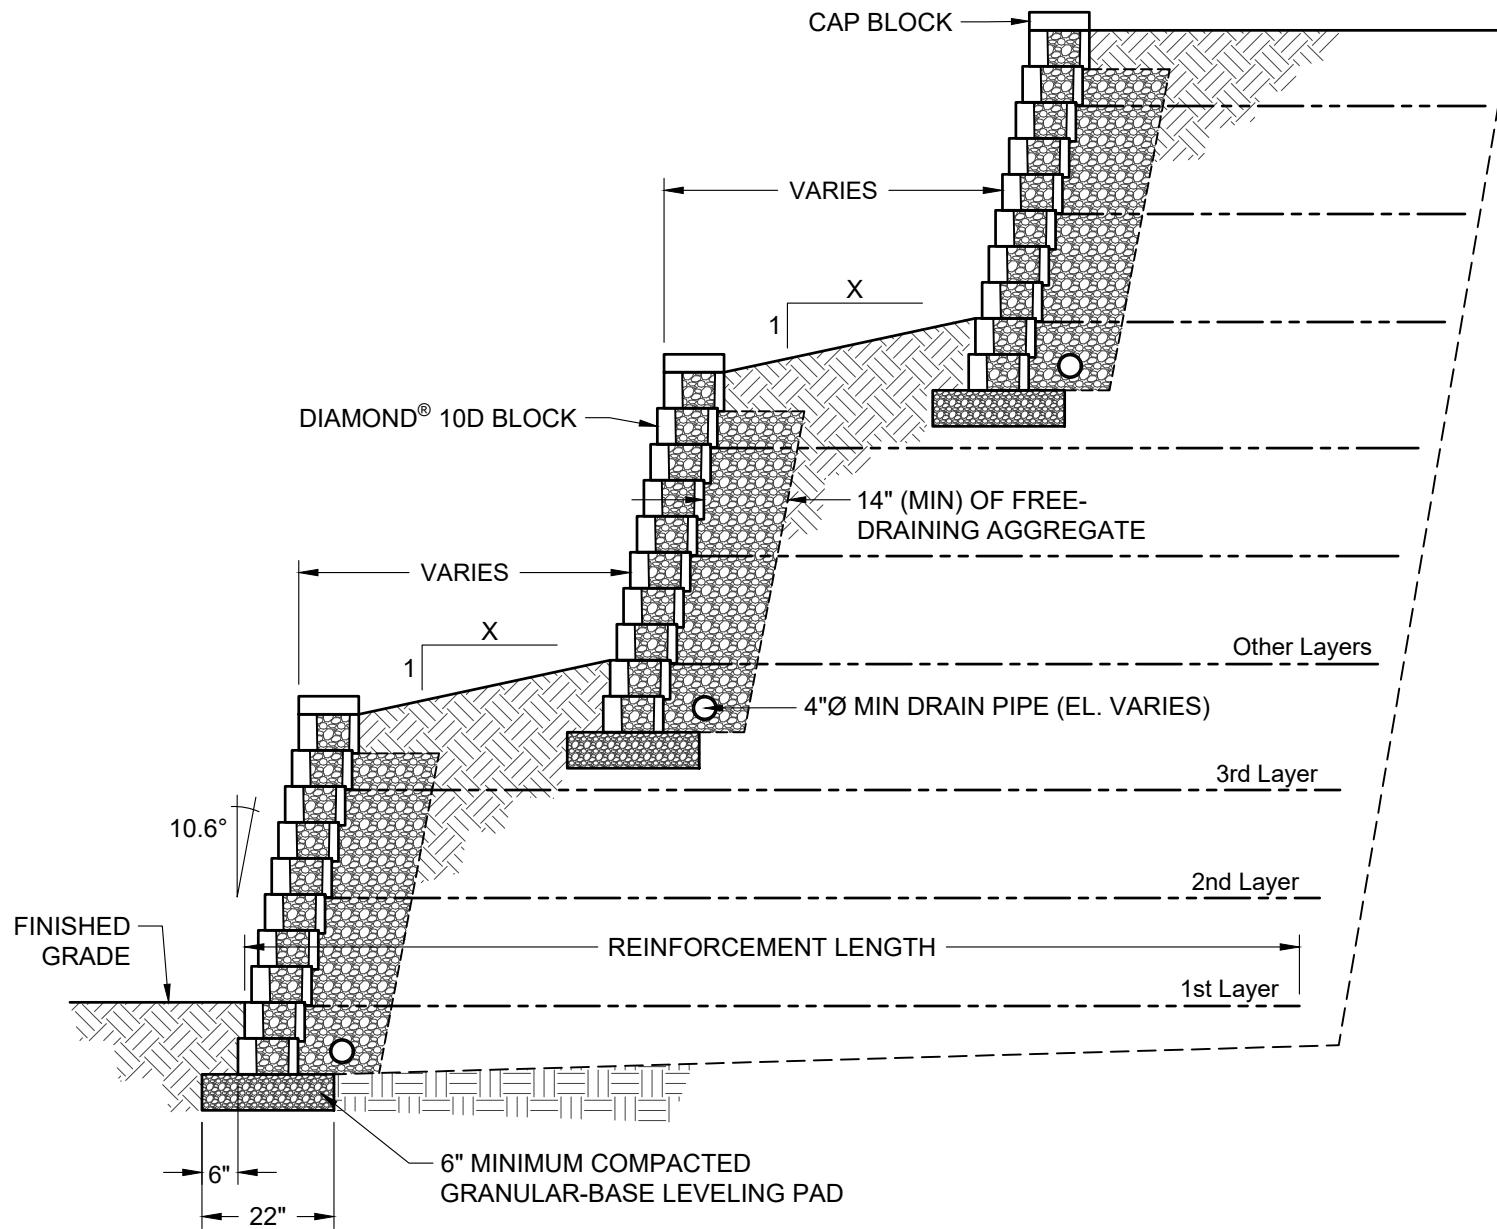
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## Diamond® 10D Retaining Wall System

### TYPICAL GUIDE RAIL CROSS SECTION

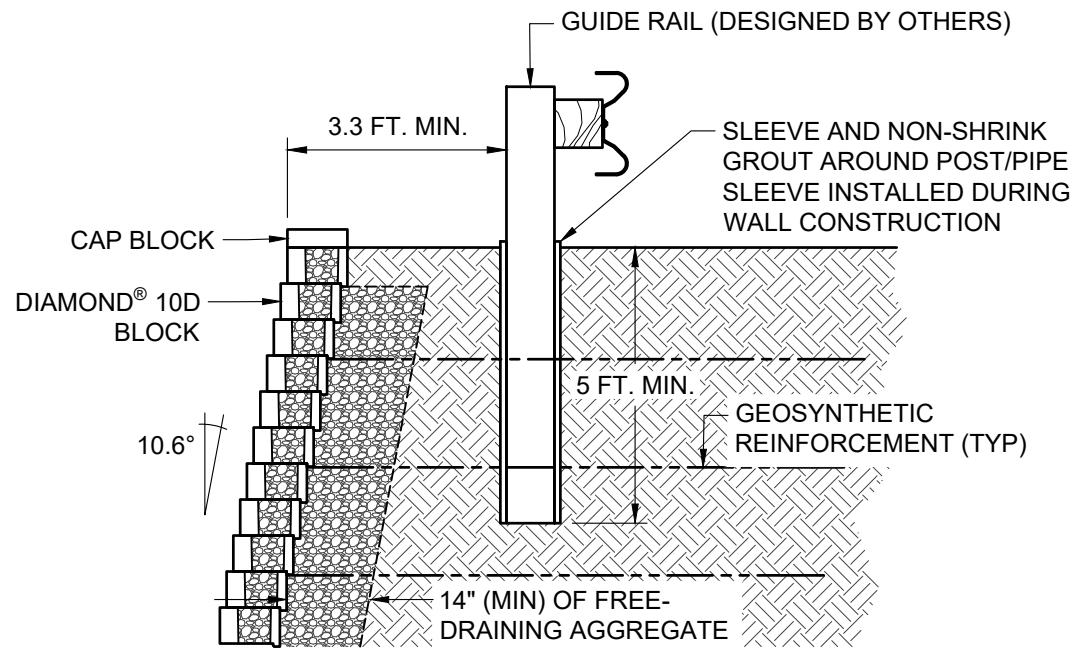Scale: 3/8" = 1'-0"	Drawn by: MAH
Date: 10/29/2025	Drawing number: D10D-09



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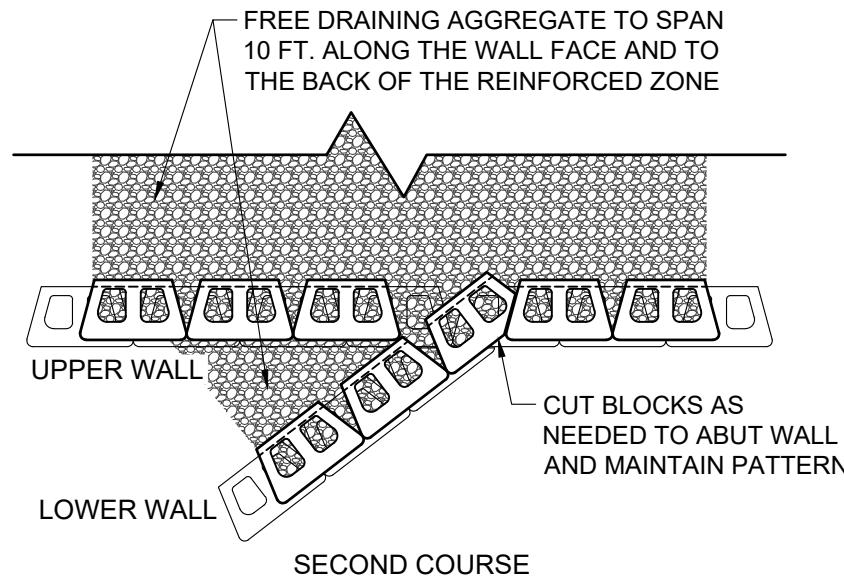
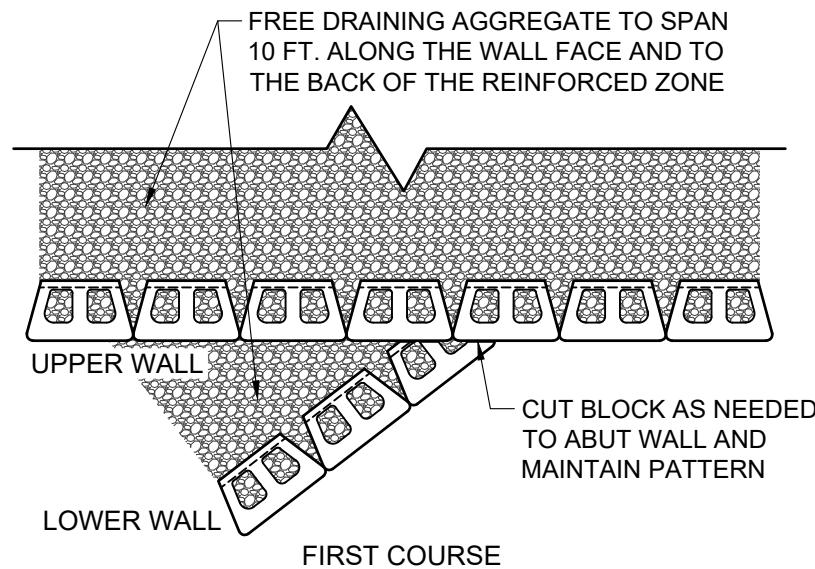
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## Diamond® 10D Retaining Wall System

### TYPICAL TERRACED CROSS SECTION

Scale: 3/8" = 1'-0"	Drawn by: MAH
Date: 10/29/2025	Drawing number: D10D-10



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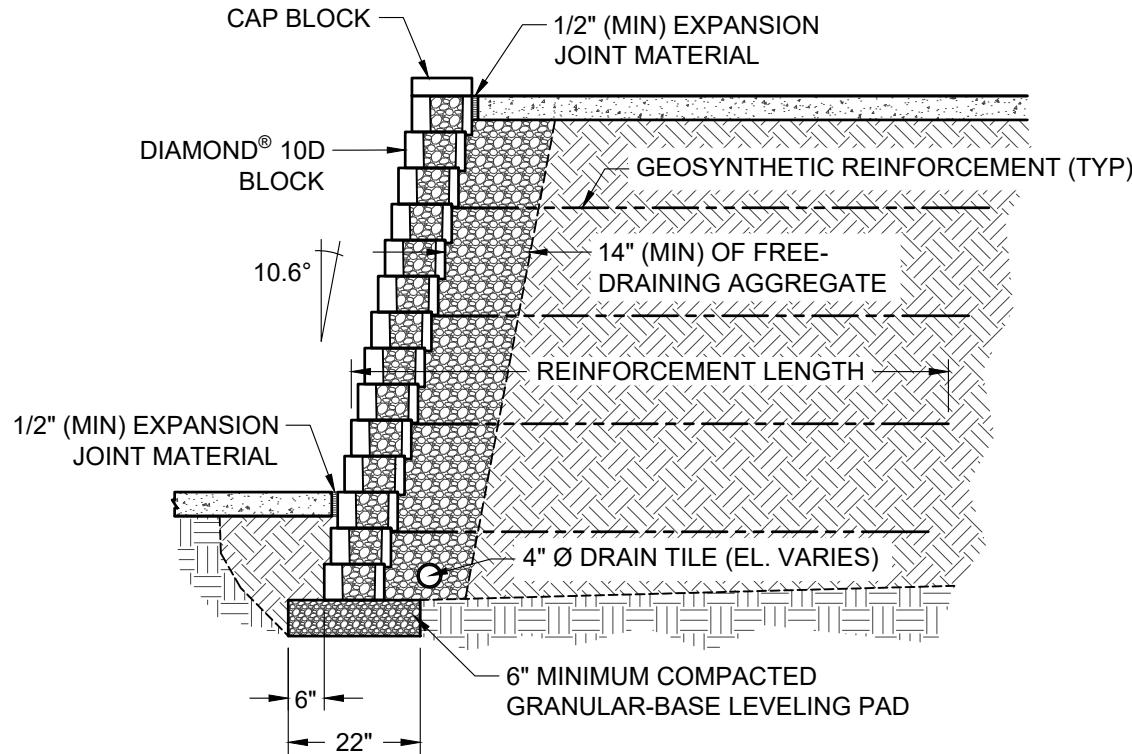
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## Diamond® 10D Retaining Wall System

### TYPICAL TERRACE CONNECTION

Scale: 3/8" = 1'-0"	Drawn by: MAH
Date: 10/29/2025	Drawing number: D10D-11



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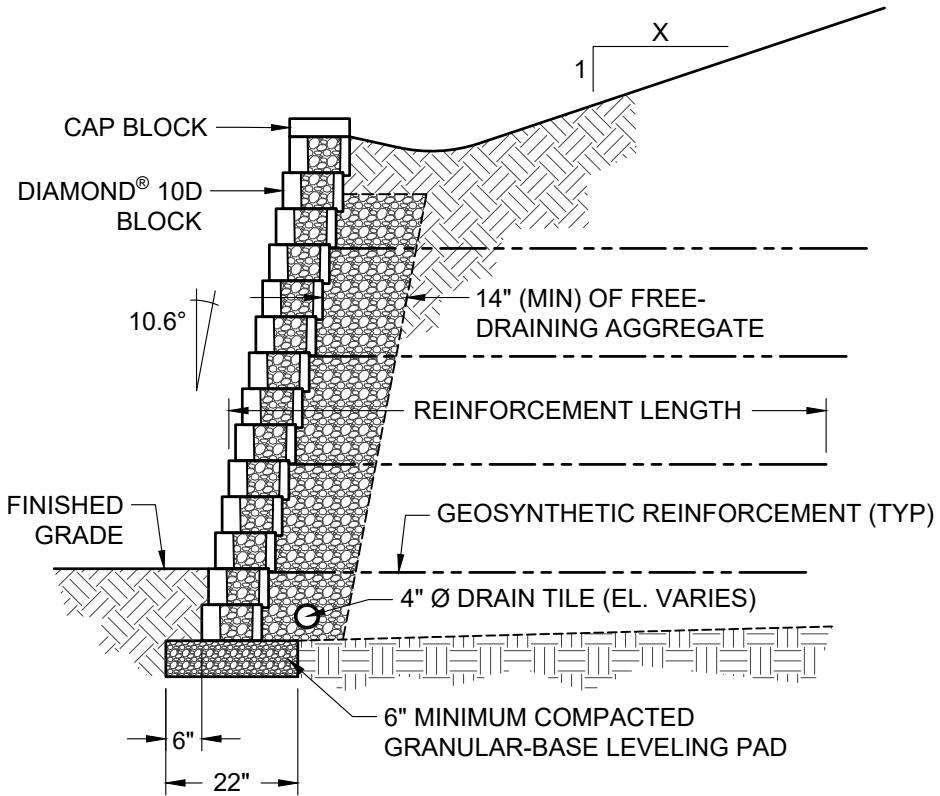
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## Diamond® 10D Retaining Wall System

### TYPICAL CROSS SECTION WITH SIDEWALK

Scale: 3/8" = 1'-0"	Drawn by: MAH
Date: 10/29/2025	Drawing number: D10D-12



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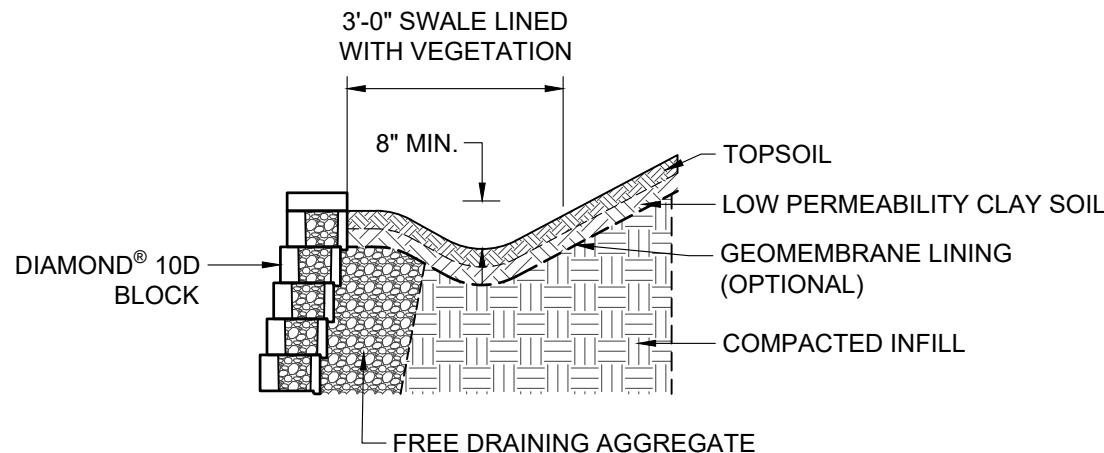
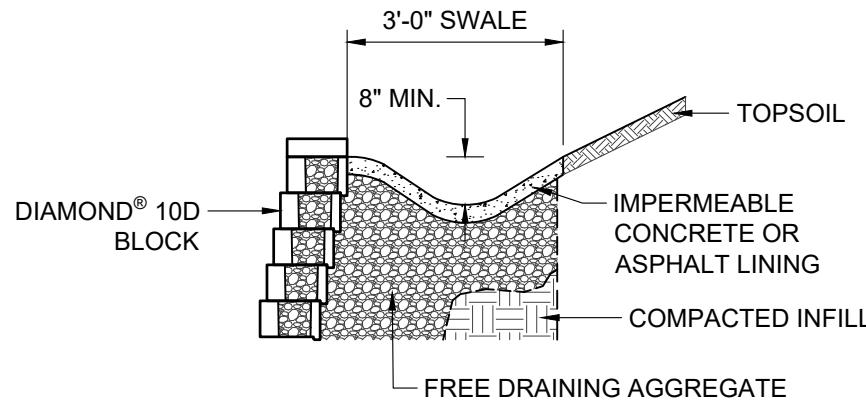
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## Diamond® 10D Retaining Wall System

### TYPICAL CROSS SECTION WITH CREST SLOPE

Scale: 3/8" = 1'-0"	Drawn by: MAH
Date: 10/29/2025	Drawing number: D10D-13



REFERENCE THE NCMA DESIGN MANUAL FOR ADDITIONAL DETAILS



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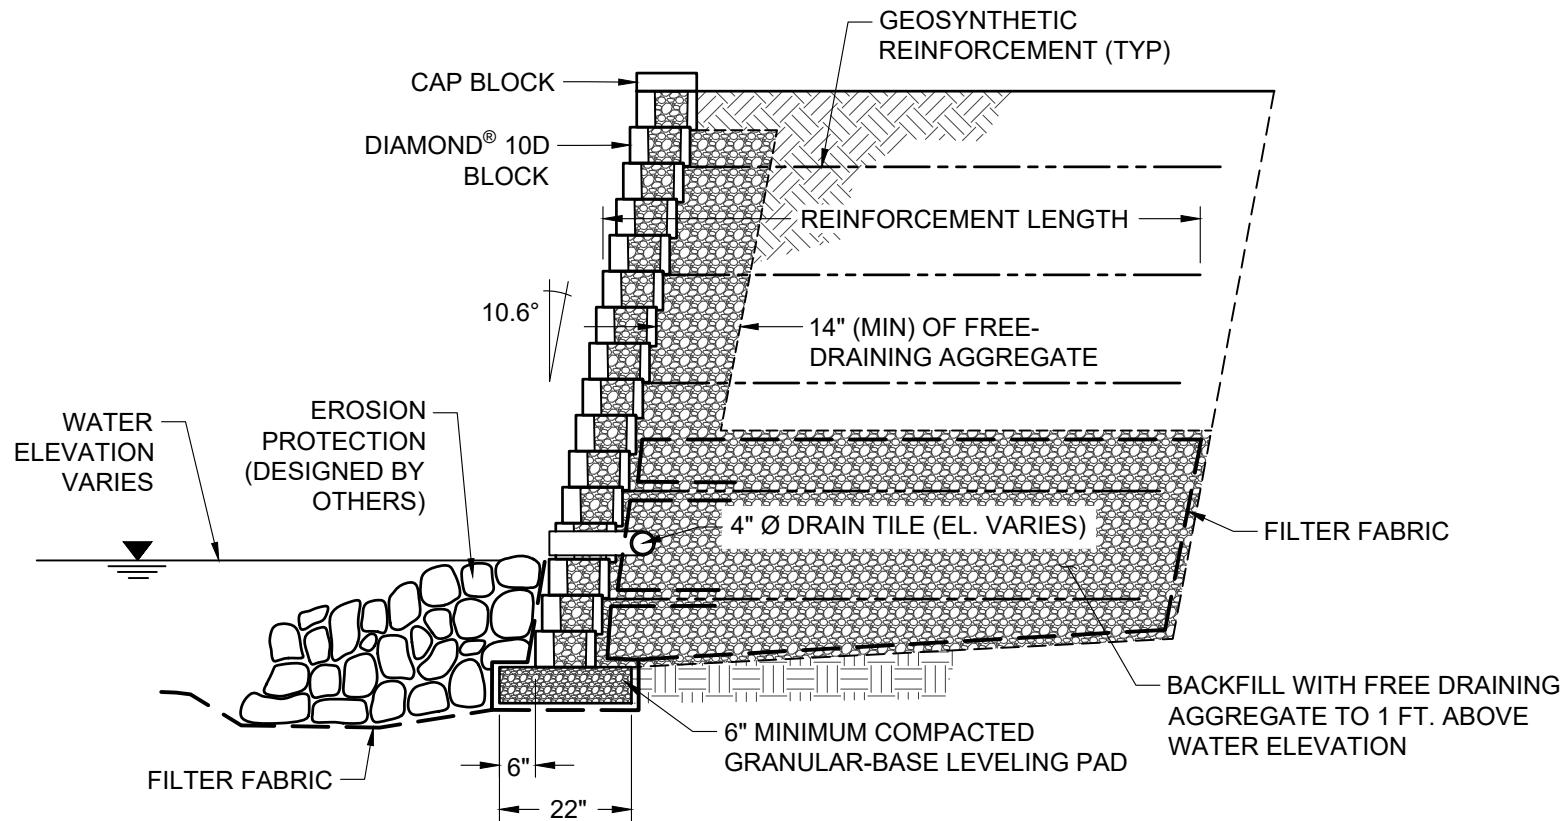
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## Diamond® 10D Retaining Wall System

### TYPICAL DRAINAGE SWALE CROSS SECTIONS

Scale: 3/8" = 1'-0"	Drawn by: MAH
Date: 10/29/2025	Drawing number: D10D-14



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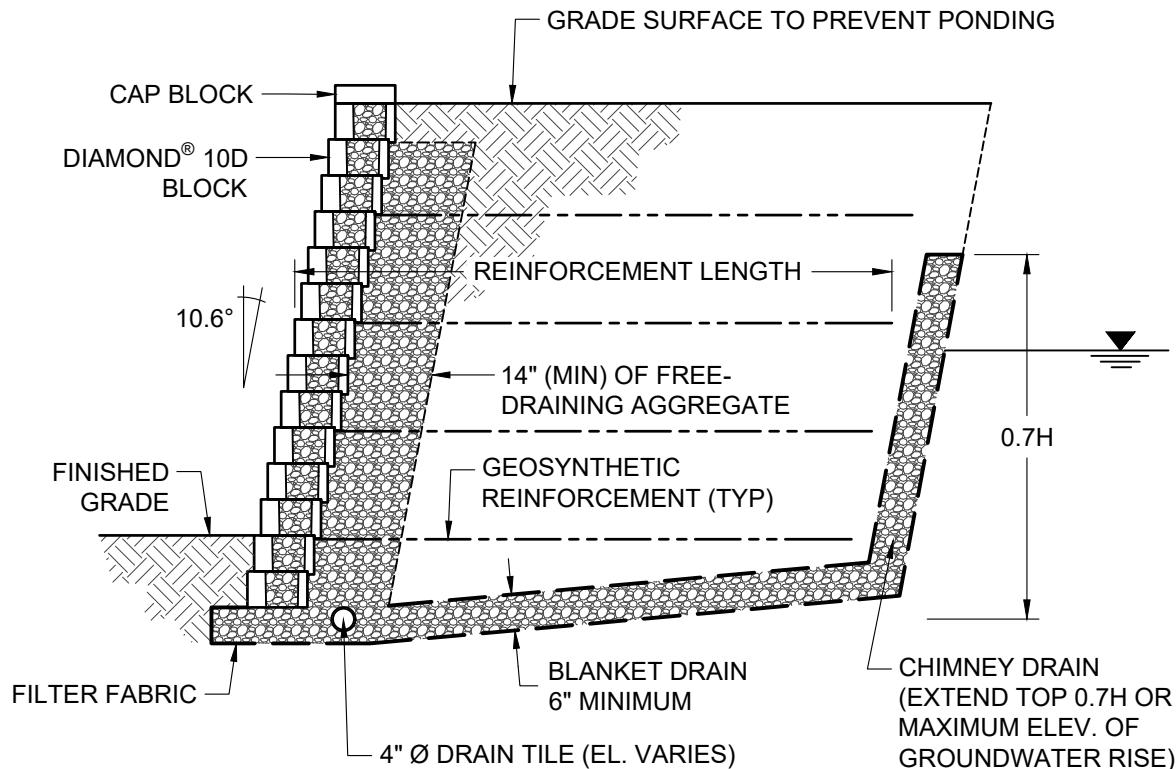
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## Diamond® 10D Retaining Wall System

### TYPICAL SHORELINE CROSS SECTION

Scale: 3/8" = 1'-0"	Drawn by: MAH
Date: 10/29/2025	Drawing number: D10D-15



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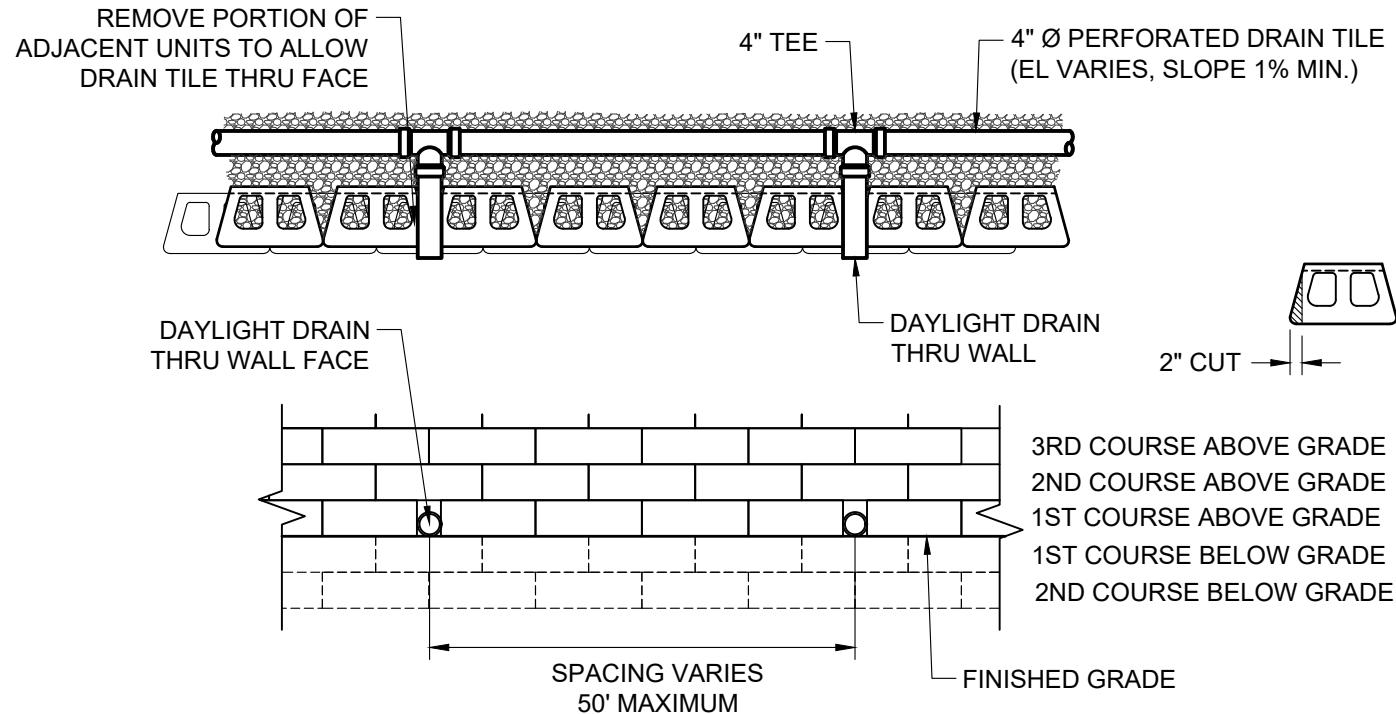
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## Diamond® 10D Retaining Wall System

### TYPICAL GROUNDWATER INTRUSION CROSS SECTION

Scale: 3/8" = 1'-0"	Drawn by: MAH
Date: 10/29/2025	Drawing number: D10D-16



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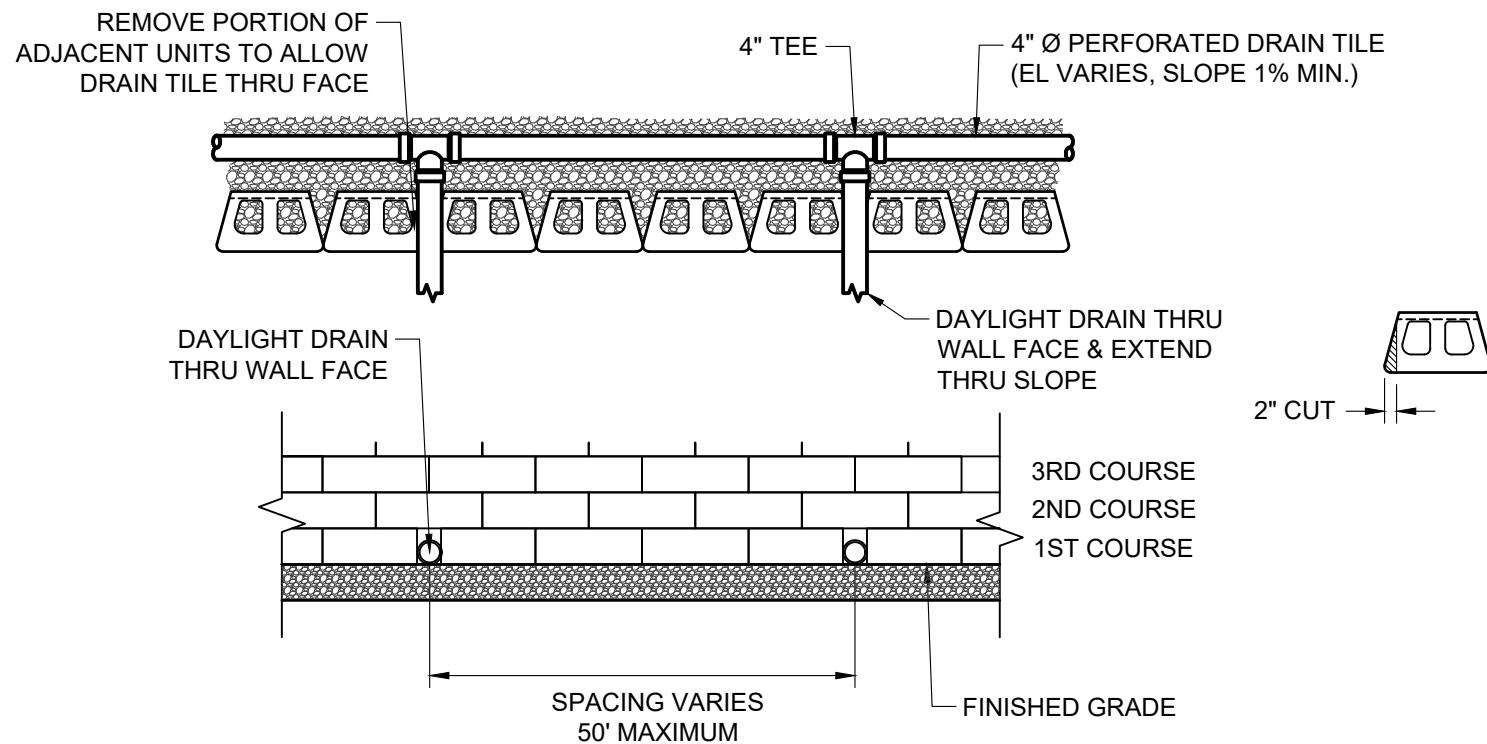
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## Diamond® 10D Retaining Wall System

### TYPICAL DRAIN PIPE THROUGH WALL FACE

Scale: 3/8" = 1'-0"	Drawn by: MAH
Date: 10/29/2025	Drawing number: D10D-17



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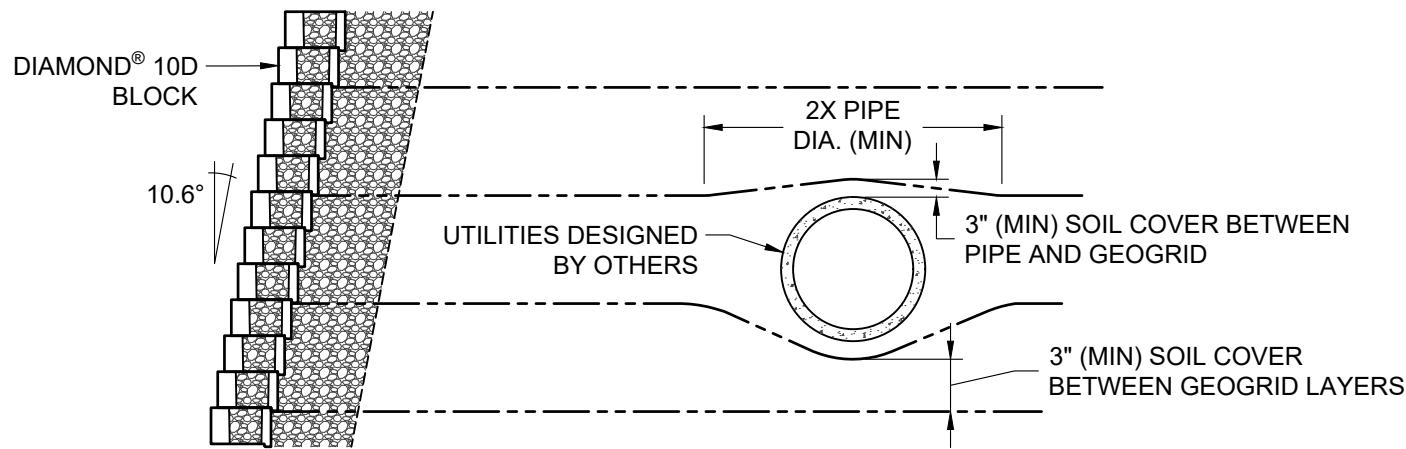
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## Diamond® 10D Retaining Wall System

### TYPICAL DRAIN PIPE THROUGH TOE SLOPE

Scale: 3/8" = 1'-0"	Drawn by: MAH
Date: 10/29/2025	Drawing number: D10D-18



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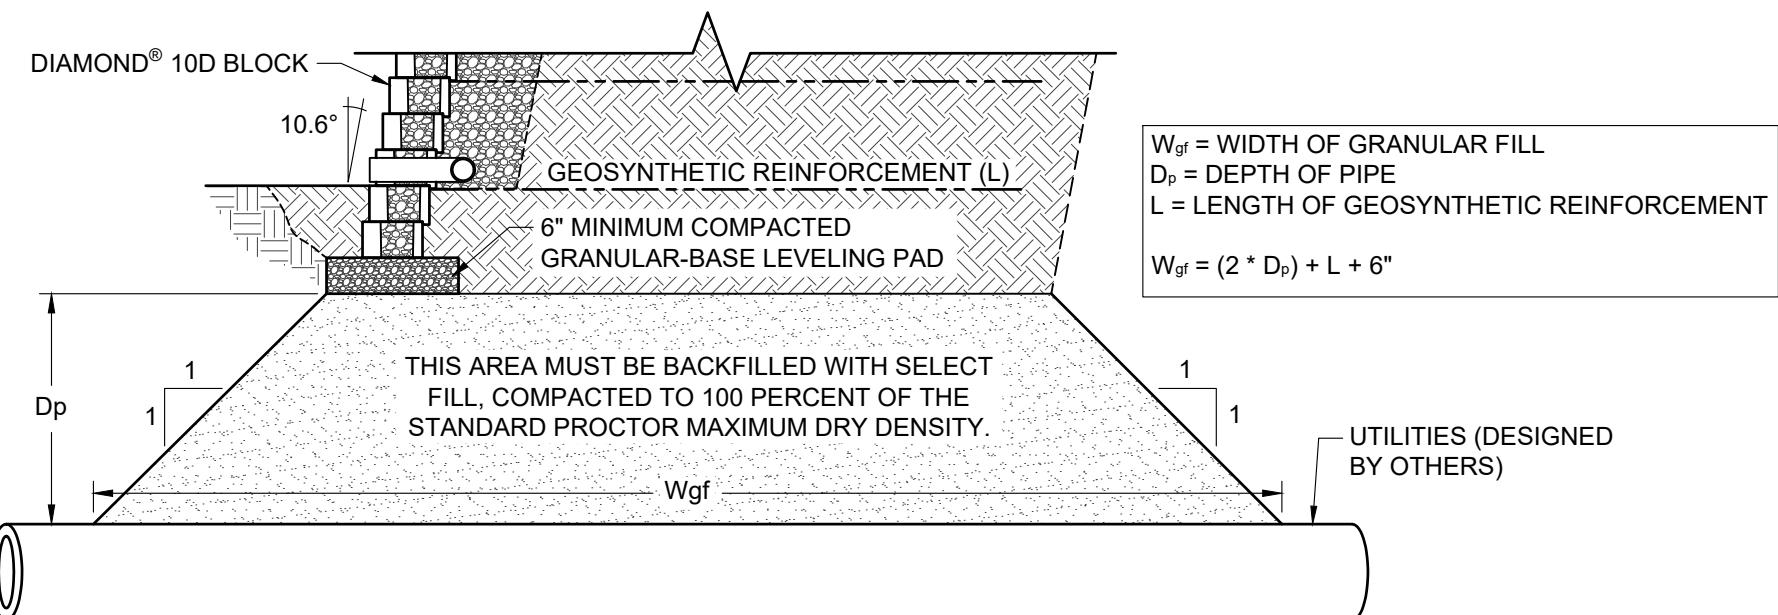
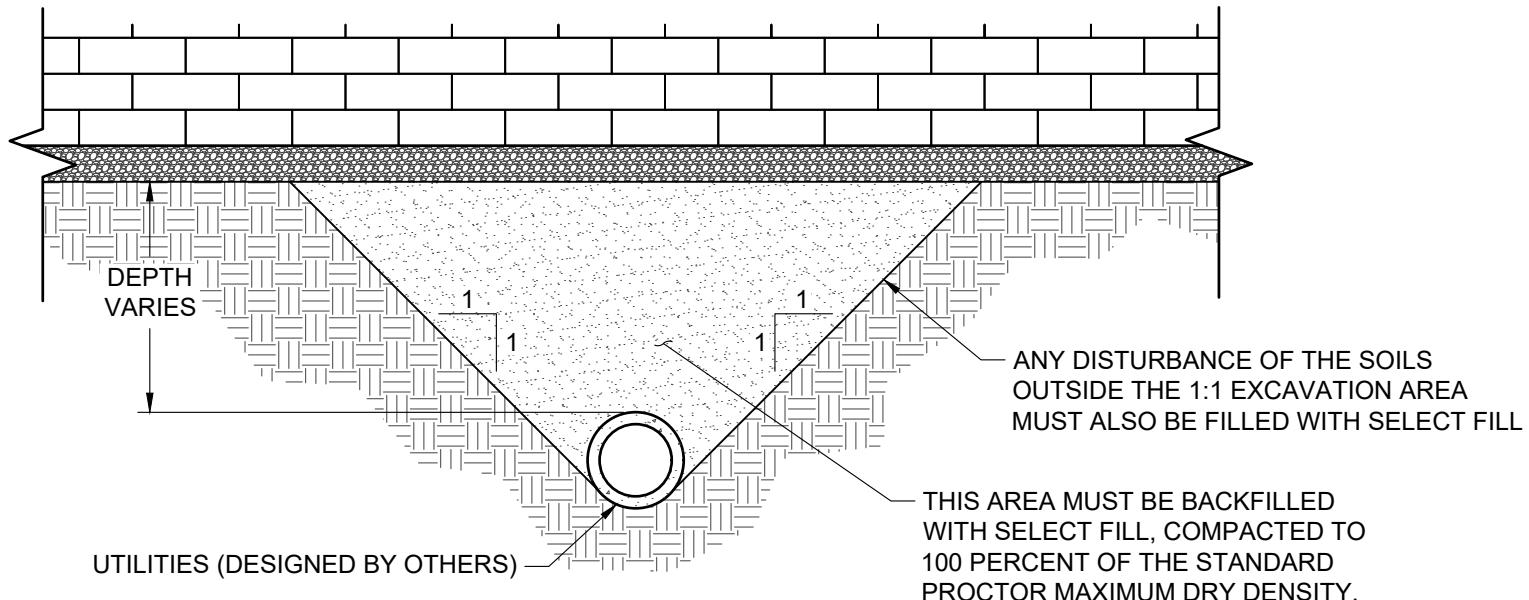
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## Diamond® 10D Retaining Wall System

### TYPICAL CROSS SECTION WITH PARALLEL UTILITIES

Scale: 3/8" = 1'-0"	Drawn by: MAH
Date: 10/29/2025	Drawing number: D10D-19



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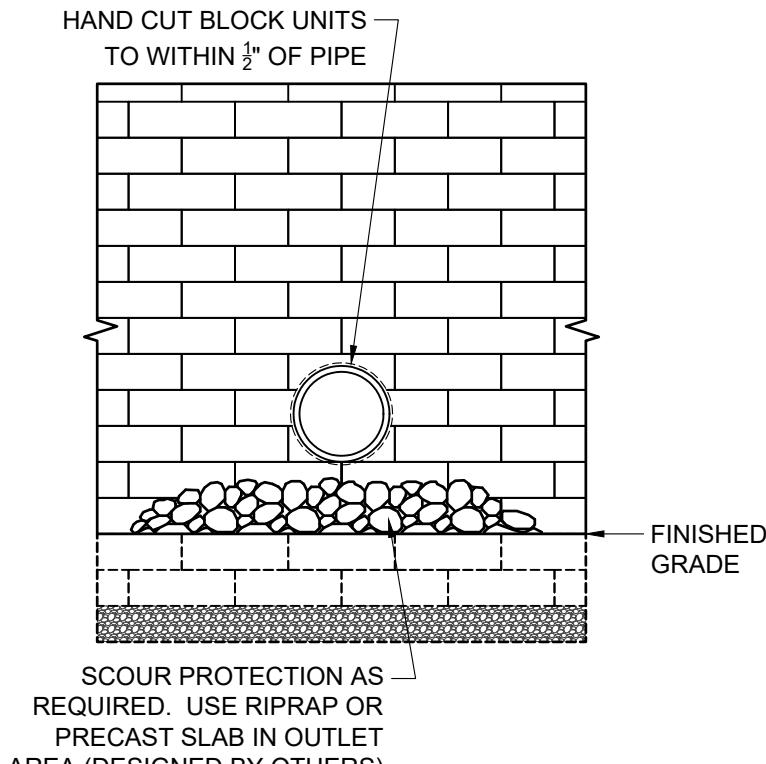
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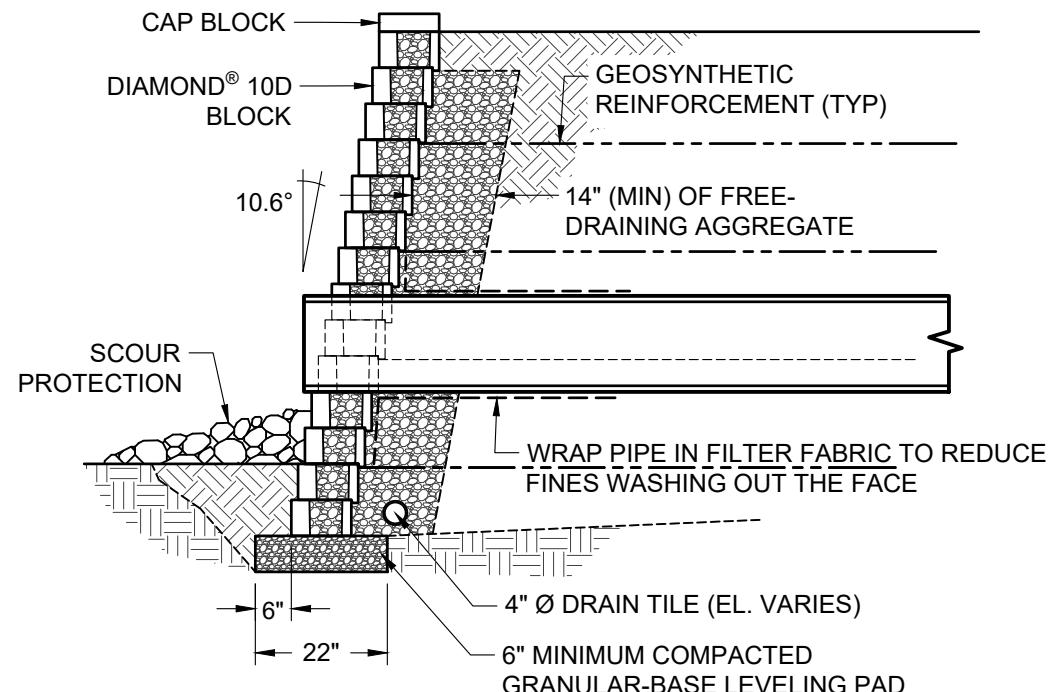
## Diamond® 10D Retaining Wall System

### TYPICAL DETAILS FOR UTILITIES BELOW WALL

Scale: 3/8" = 1'-0"	Drawn by: MAH
Date: 10/29/2025	Drawing number: D10D-20



FACE VIEW



SECTION VIEW



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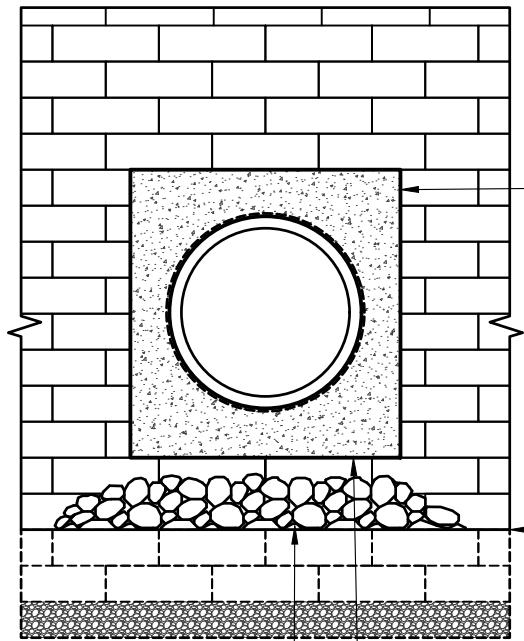
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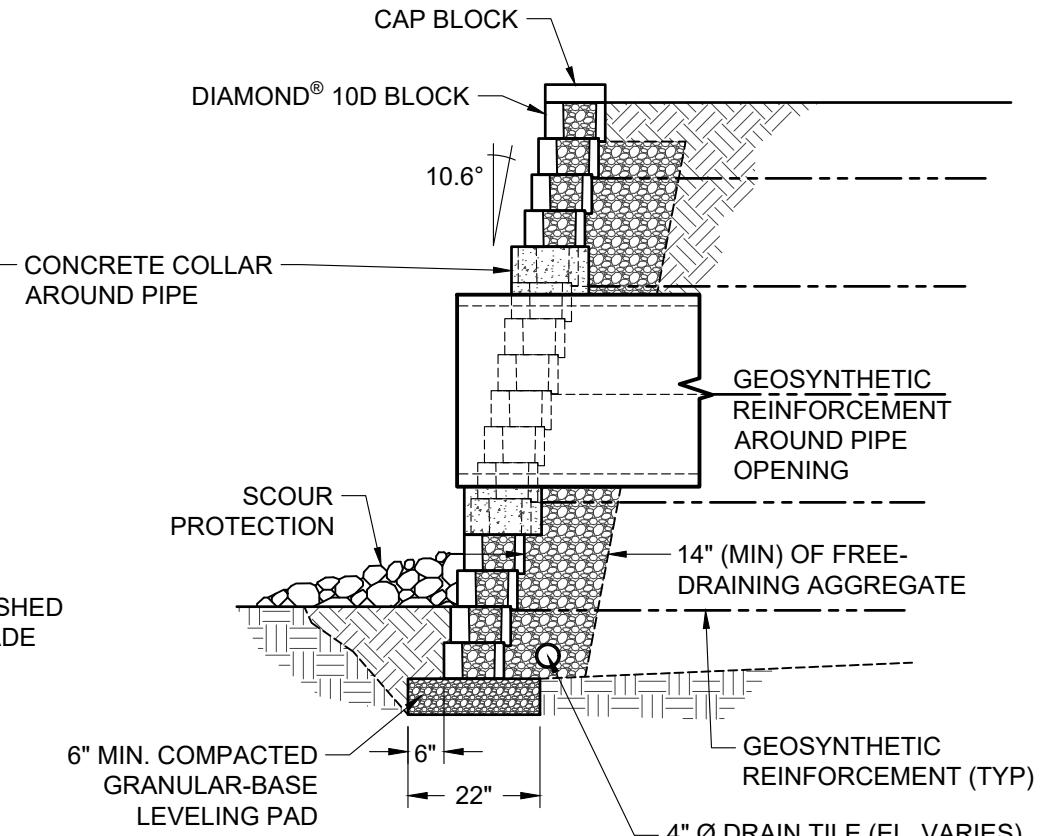
## Diamond® 10D Retaining Wall System

TYPICAL DETAILS FOR SMALL UTILITIES THROUGH WALL

Scale: 3/8" = 1'-0"	Drawn by: MAH
Date: 10/29/2025	Drawing number: D10D-21



FACE VIEW



SECTION VIEW




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**Diamond® 10D Retaining Wall System**  
**TYPICAL DETAILS FOR LARGE UTILITIES THROUGH WALL**

Scale: 3/8" = 1'-0"	Drawn by: MAH
Date: 10/29/2025	Drawing number: D10D-22



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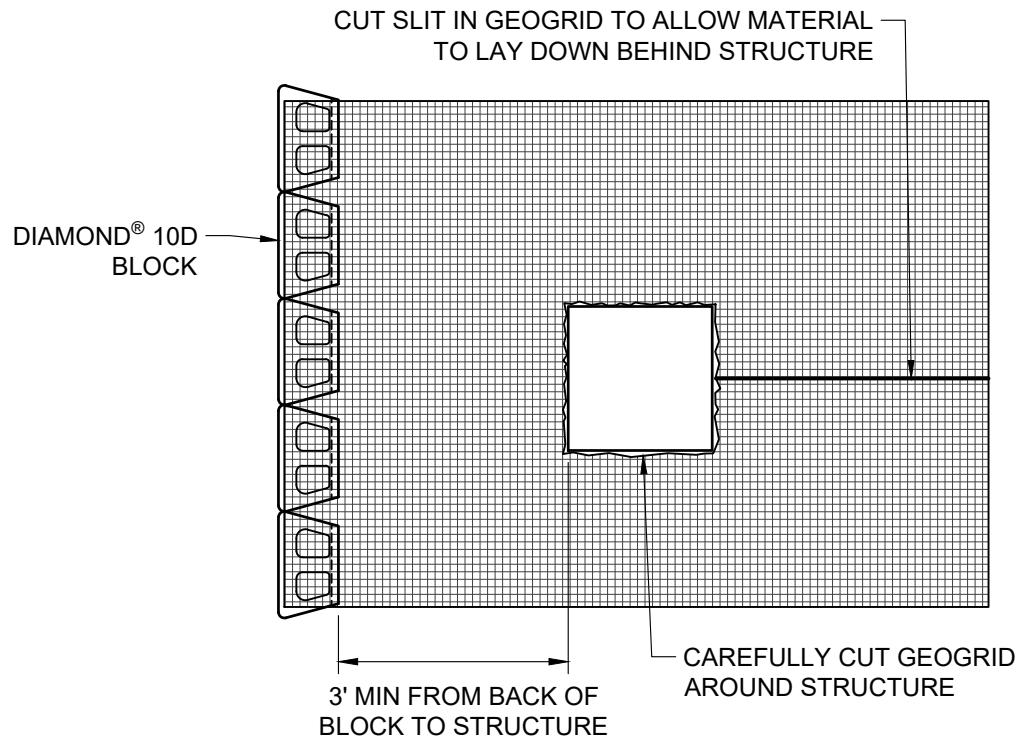
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## Diamond® 10D Retaining Wall System

### TYPICAL DETAILS DROP STRUCTURE BEHIND WALL

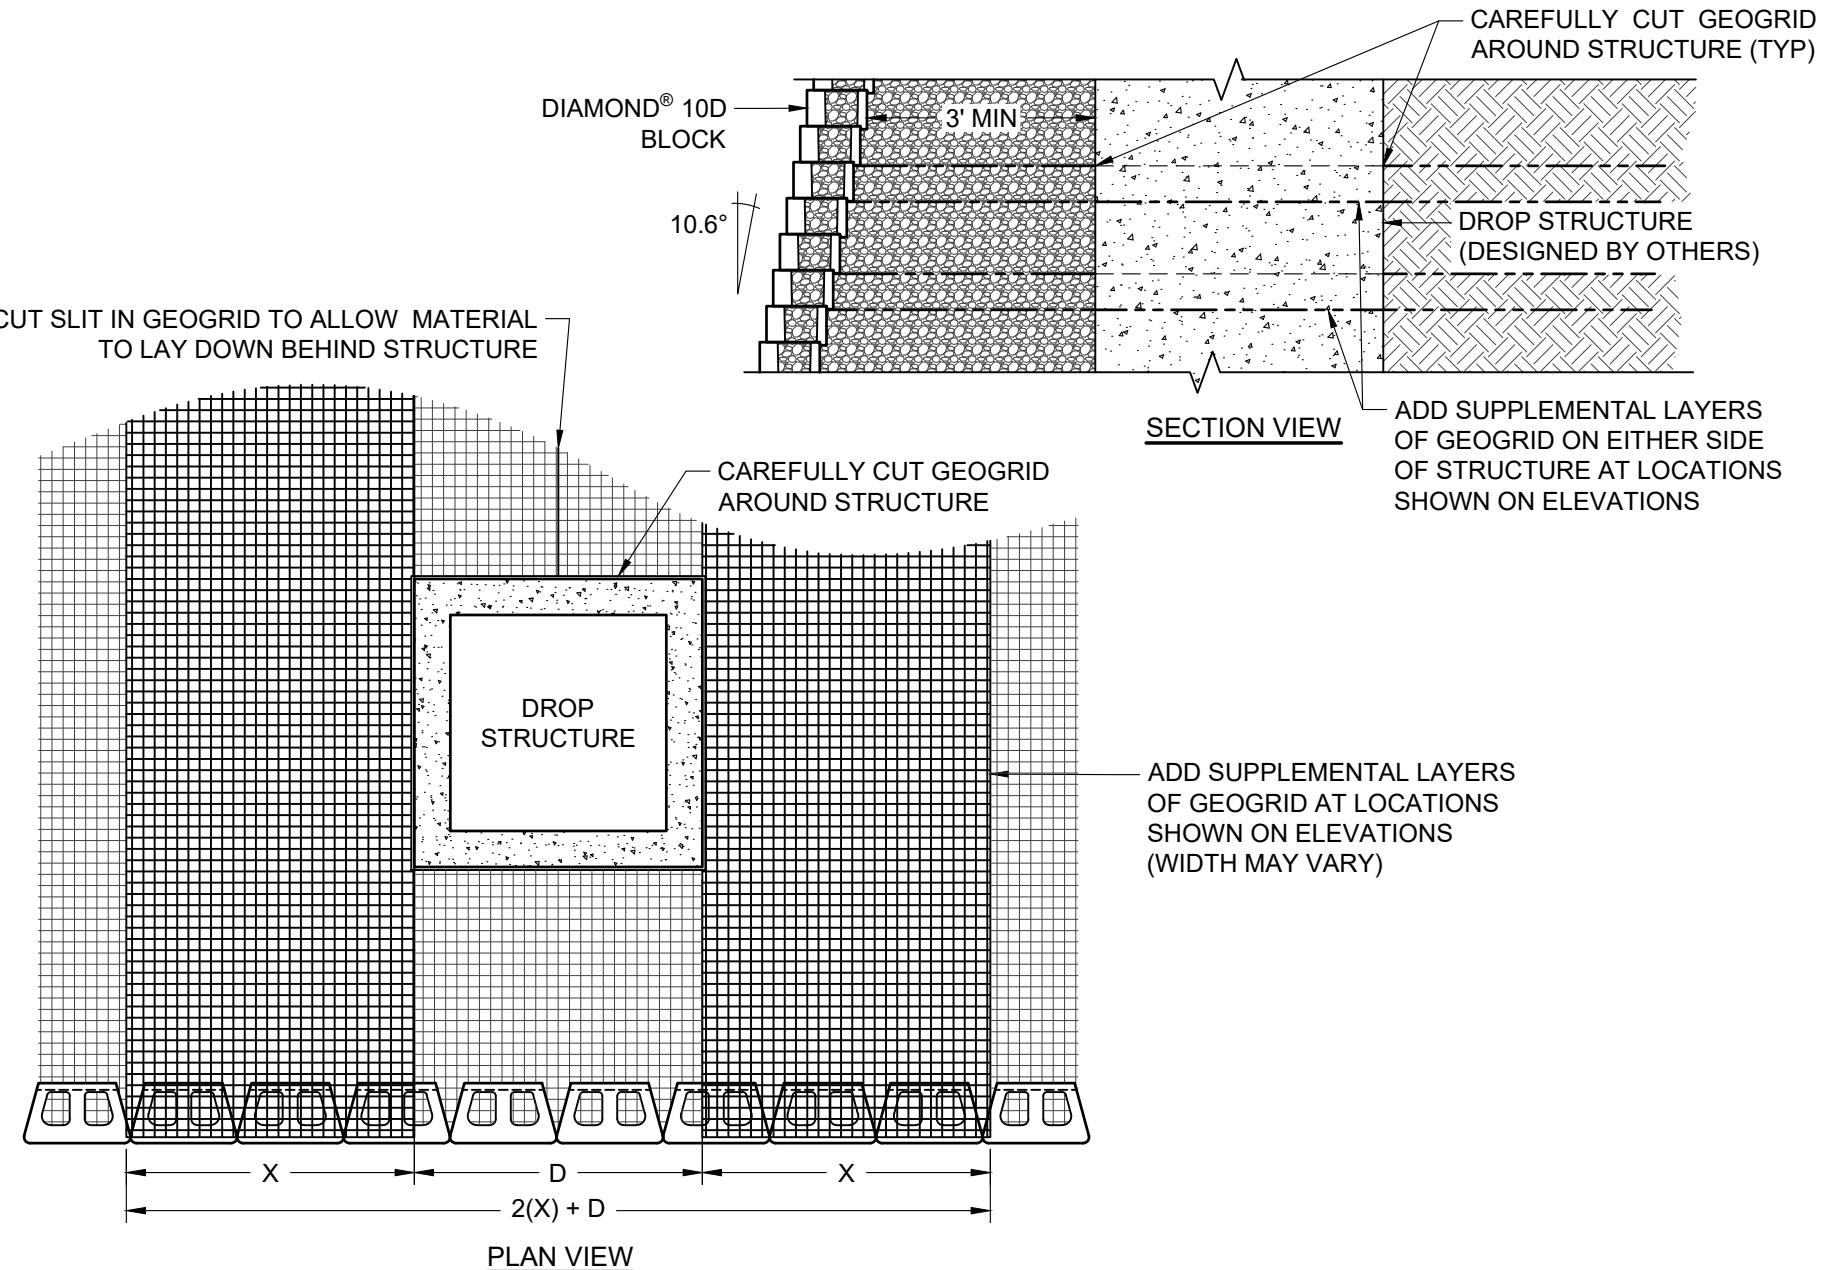Scale: 3/8" = 1'-0"	Drawn by: MAH
Date: 10/29/2025	Drawing number: D10D-23



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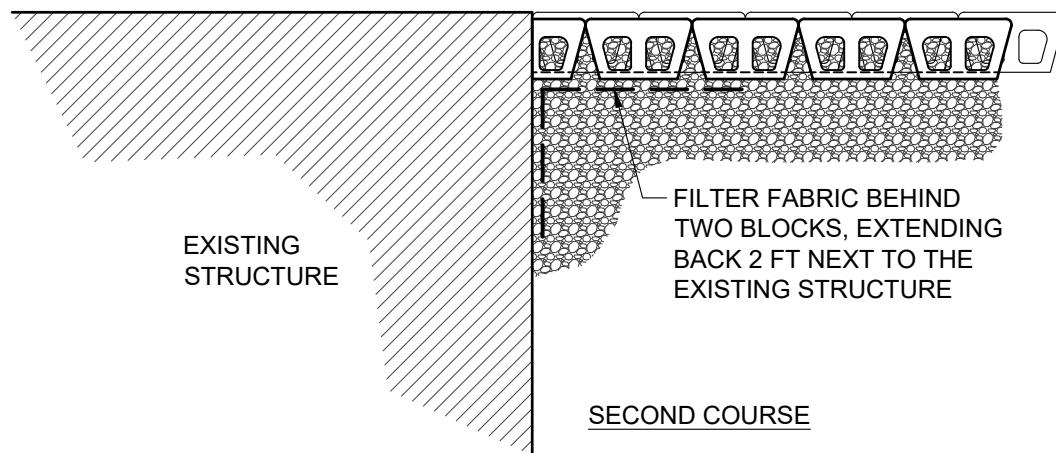
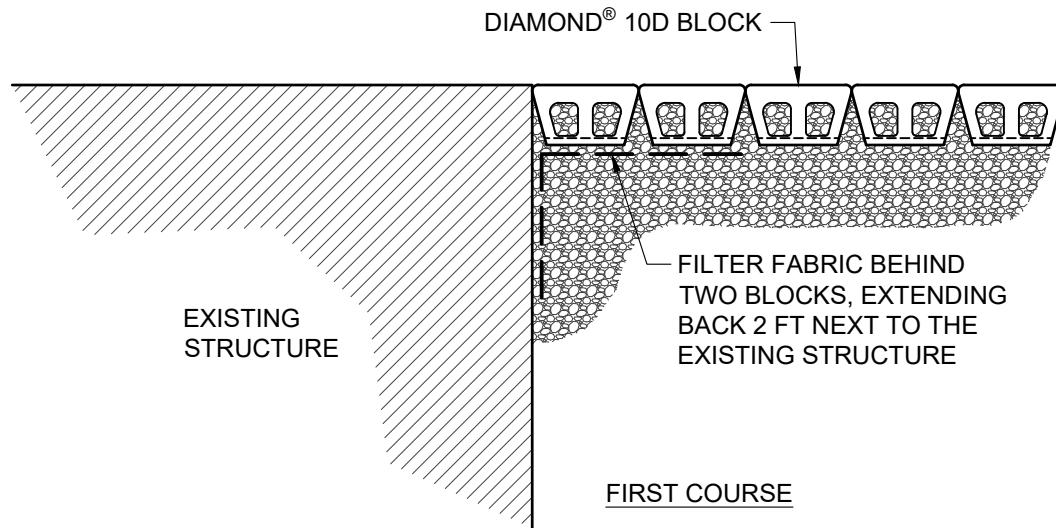
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## Diamond® 10D Retaining Wall System

TYPICAL DETAIL ALTERNATE DROP STRUCTURE BEHIND WALL

Scale: 3/8" = 1'-0"	Drawn by: MAH
Date: 10/29/2025	Drawing number: D10D-24



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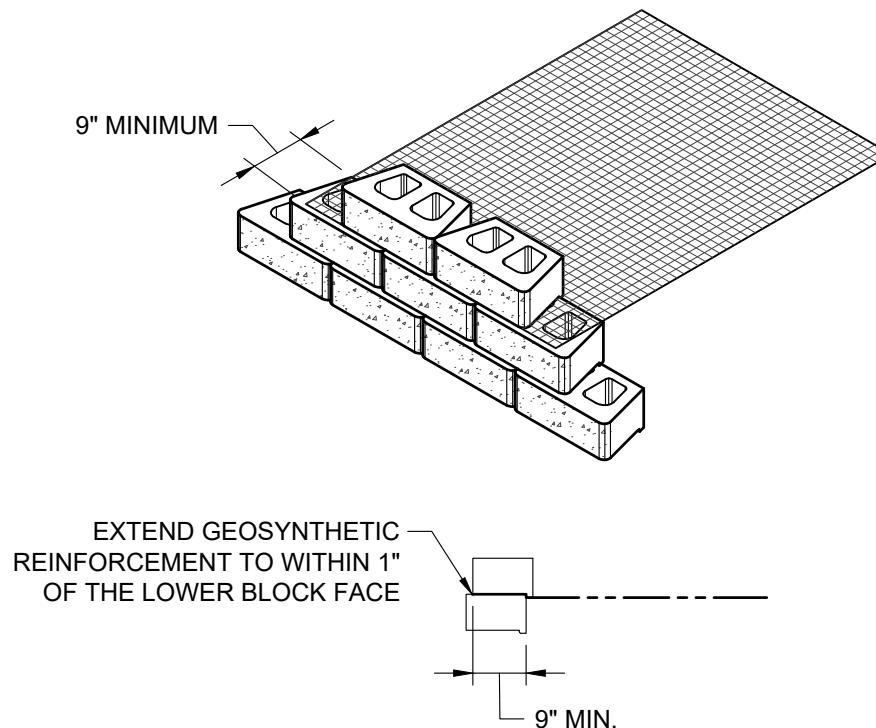
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## Diamond® 10D Retaining Wall System

### TYPICAL DETAIL WALL ABUTTING STRUCTURE

Scale: 3/8" = 1'-0"	Drawn by: MAH
Date: 10/29/2025	Drawing number: D10D-25



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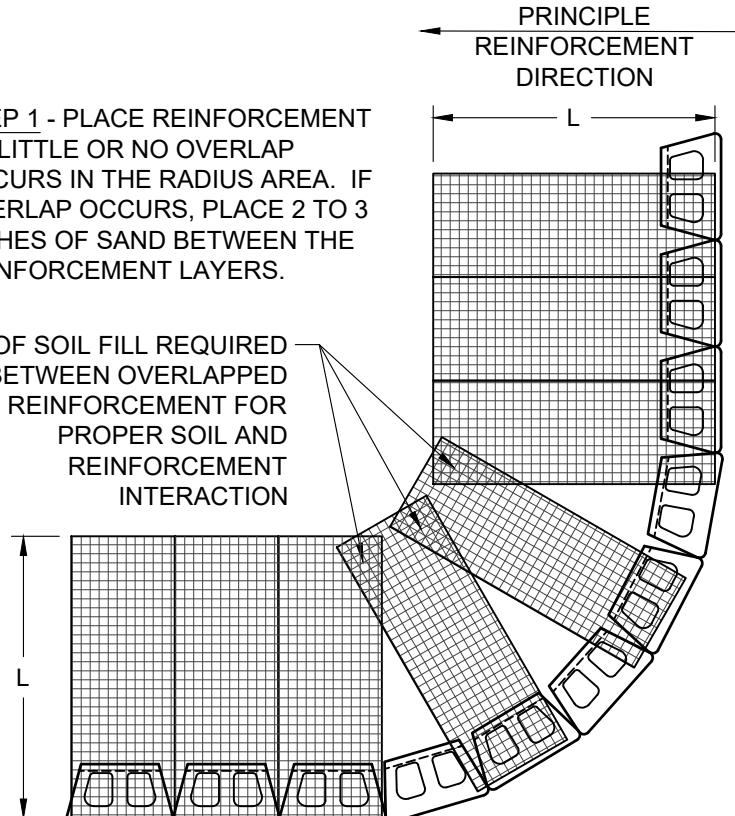
## Diamond® 10D Retaining Wall System

### TYPICAL REINFORCEMENT CONNECTION DETAIL


Scale: NONE	Drawn by: MAH
Date: 10/29/2025	Drawing number: D10D-26

STEP 1 - PLACE REINFORCEMENT SO LITTLE OR NO OVERLAP OCCURS IN THE RADIUS AREA. IF OVERLAP OCCURS, PLACE 2 TO 3 INCHES OF SAND BETWEEN THE REINFORCEMENT LAYERS.


2"-3" OF SOIL FILL REQUIRED BETWEEN OVERLAPPED REINFORCEMENT FOR PROPER SOIL AND REINFORCEMENT INTERACTION



STEP 2: LAY THE NEXT COURSE OF BLOCK. MAKE A MARK ON THE BACK OF THE BLOCKS IN THE AREAS THAT ARE NOT REINFORCED. BACKFILL AND COMPACT THAT COURSE.

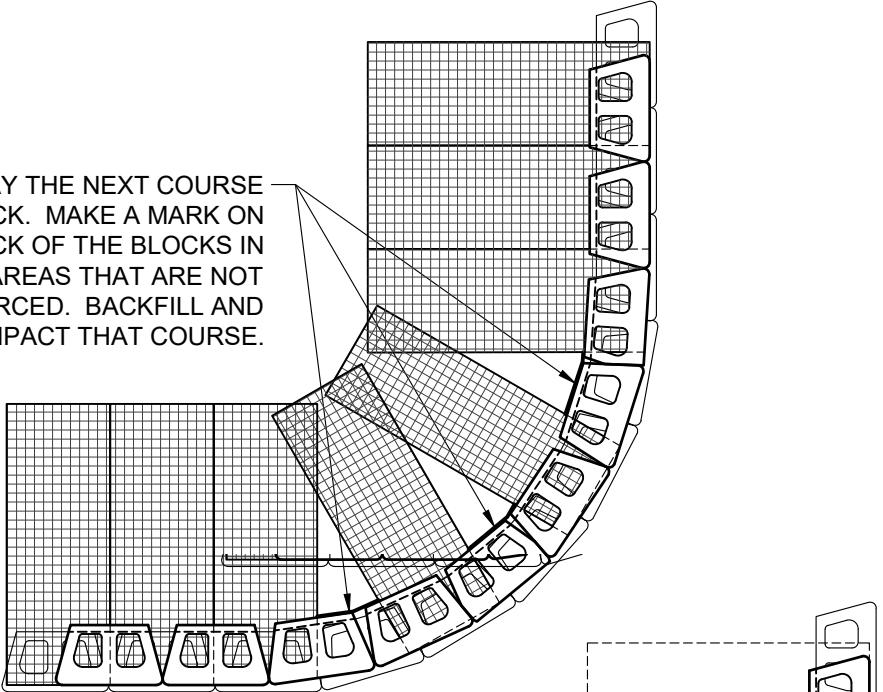

STEP 3: PLACE REINFORCEMENT IN THE AREAS WHERE THE MARKS SHOW GAPS IN THE LOWER REINFORCEMENT PATTERN. CONTINUE NORMAL WALL CONSTRUCTION, REPEATING THESE STEPS AS NEEDED.

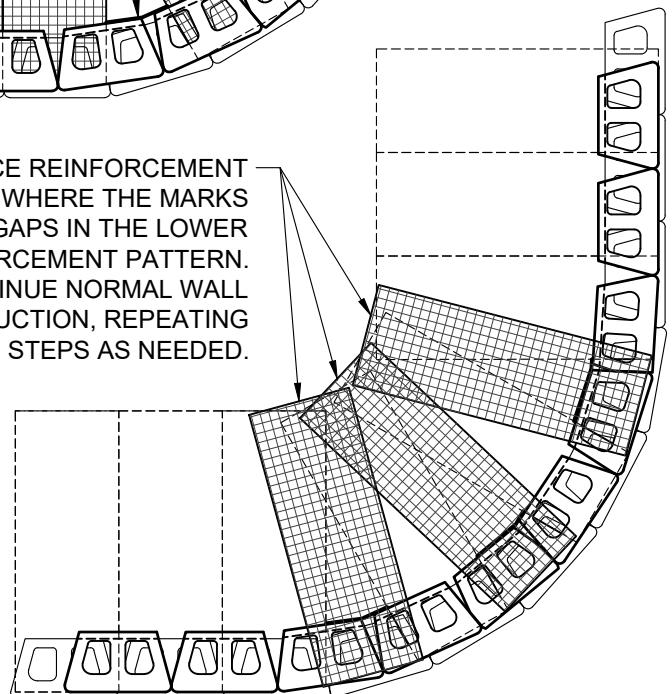

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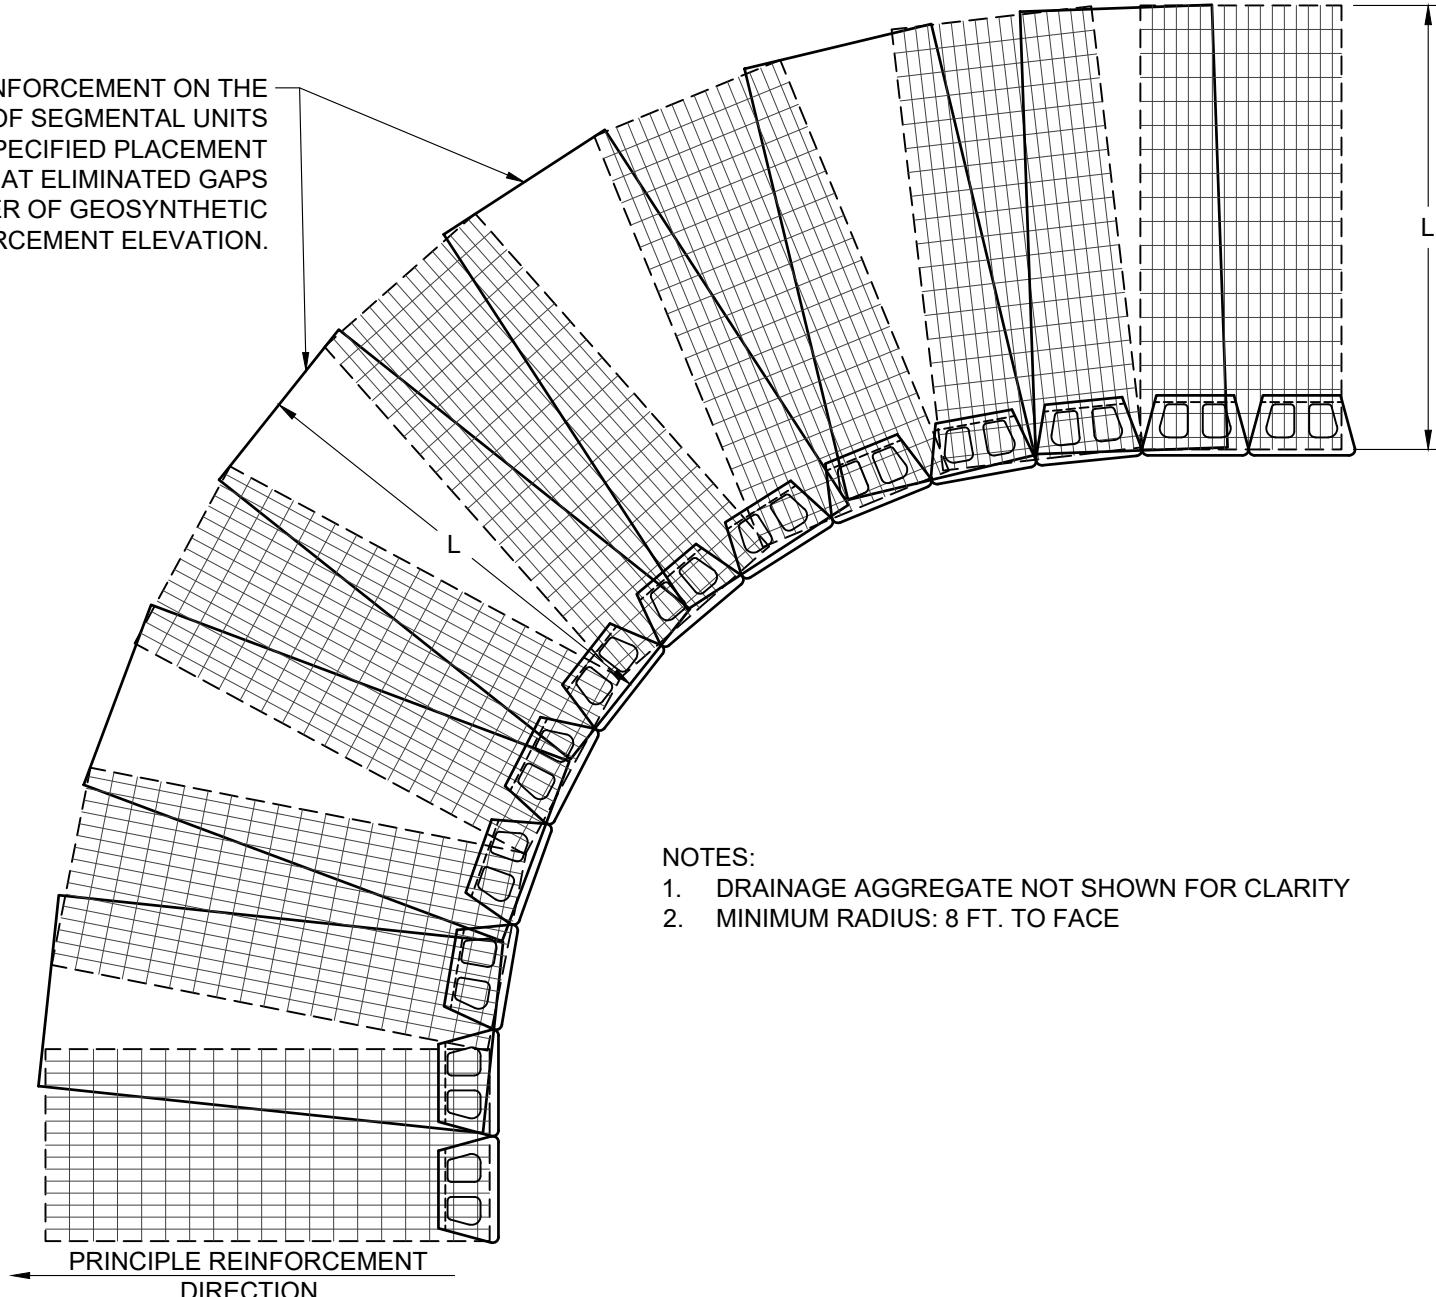
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Diamond® 10D Retaining Wall System  
TYPICAL DETAIL OUTSIDE CURVES

Scale: 3/8" = 1'-0"	Drawn by: MAH
Date: 10/29/2025	Drawing number: D10D-27

PLACE ADDITIONAL REINFORCEMENT ON THE  
NEXT COURSE OF SEGMENTAL UNITS  
IMMEDIATELY ABOVE THE SPECIFIED PLACEMENT  
ELEVATION IN A MANNER THAT ELIMINATED GAPS  
LEFT BY THE PREVIOUS LAYER OF GEOSYNTHETIC  
AT THE SPECIFIED REINFORCEMENT ELEVATION.



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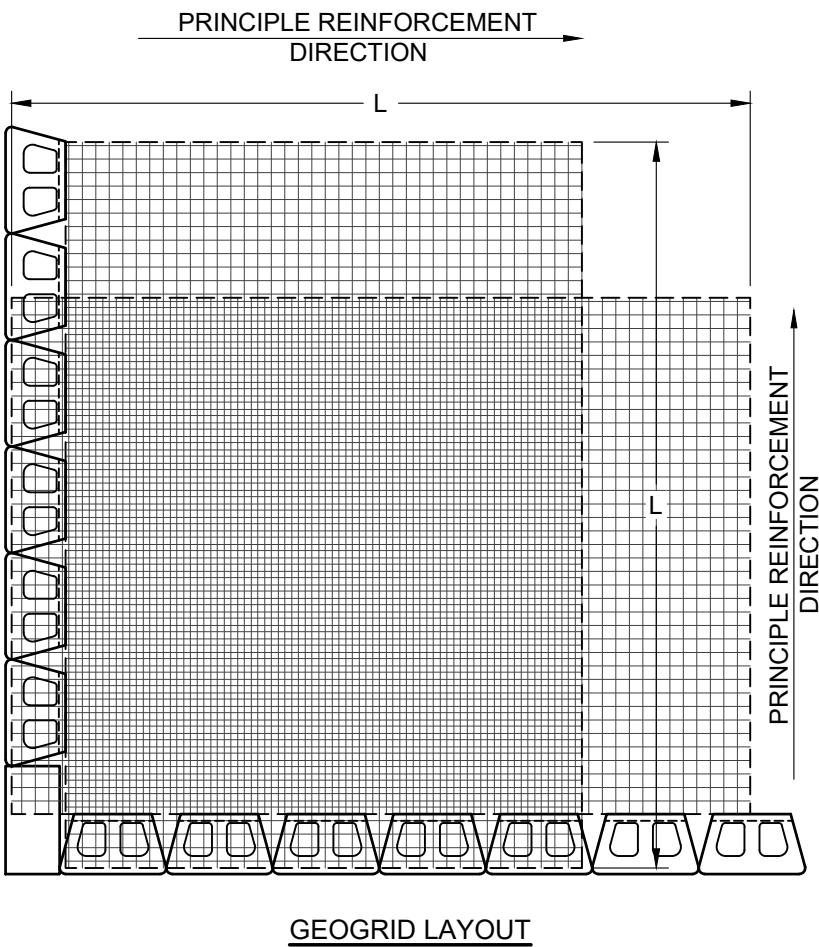
### TYPICAL DETAIL INSIDE CURVES

Scale: 3/8" = 1'-0"	Drawn by: MAH
Date: 10/29/2025	Drawing number: D10D-28




NOTE:

IN THE "CROSS-OVER AREA" OF REINFORCEMENT, ONE OF THE LAYERS OF REINFORCEMENT SHOULD BE LOWERED OR RAISED ONE COURSE TO ALLOW PLACEMENT OF THE REINFORCEMENT WITH THE PRINCIPLE REINFORCEMENT STRENGTH DIRECTION PROPERLY ORIENTATED. THE REINFORCEMENT SHOULD NOT EXTEND INTO THE SEGMENTAL RETAINING WALL UNITS ON THE RETURN LEG OF THE 90-DEGREE CORNER.



NOTE: USE ADHESIVE ON EXPOSED PARTIAL UNITS  
CUT UNITS (X) TO MAINTAIN RUNNING BOND

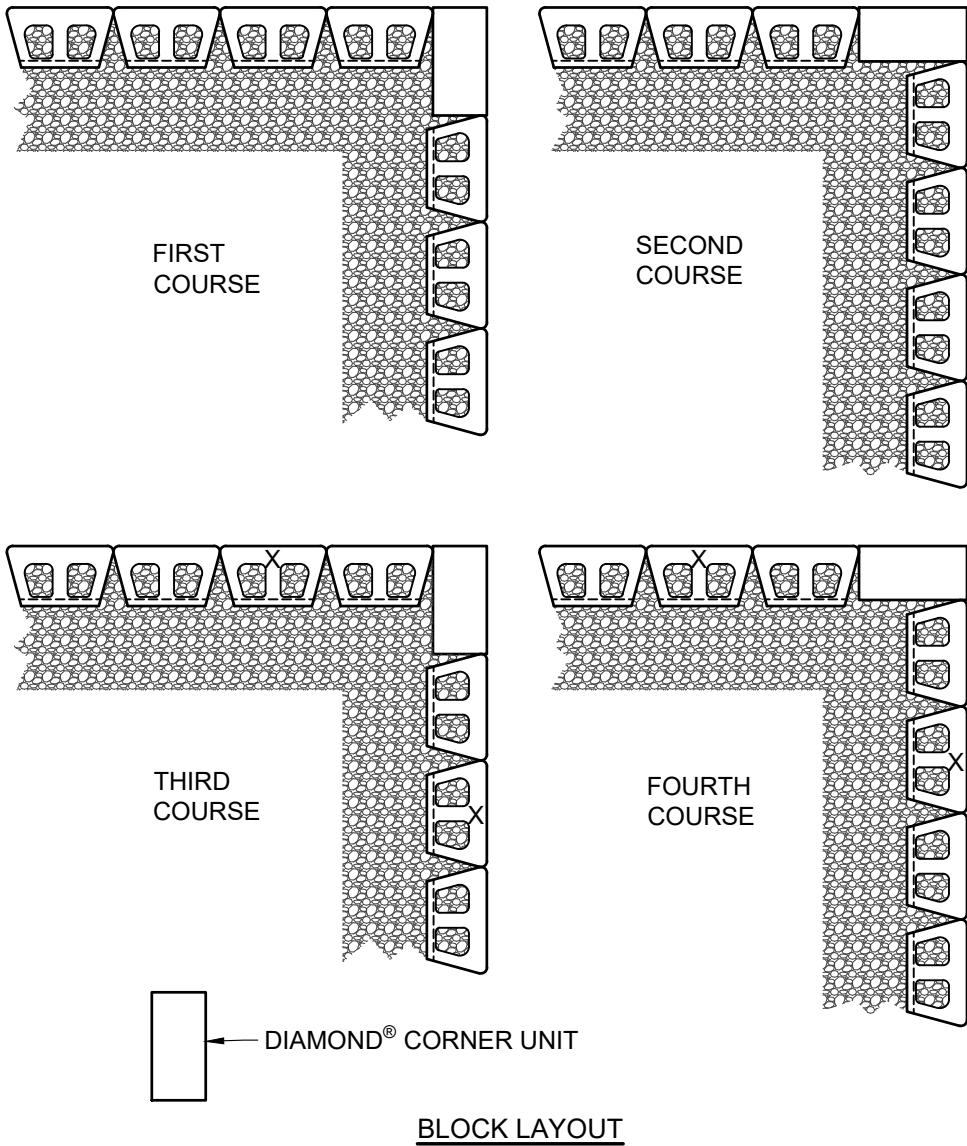

This drawing is for illustrative purposes only and should not be used for construction without the signature of a registered professional engineer.



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Diamond® 10D Retaining Wall System  
TYPICAL DETAIL OUTSIDE CORNERS

Scale: 3/8" = 1'-0"	Drawn by: MAH
Date: 10/29/2025	Drawing number: D10D-29

NOTE: USE ADHESIVE ON EXPOSED PARTIAL UNITS  
CUT UNITS (X) TO MAINTAIN RUNNING BOND



BLOCK LAYOUT

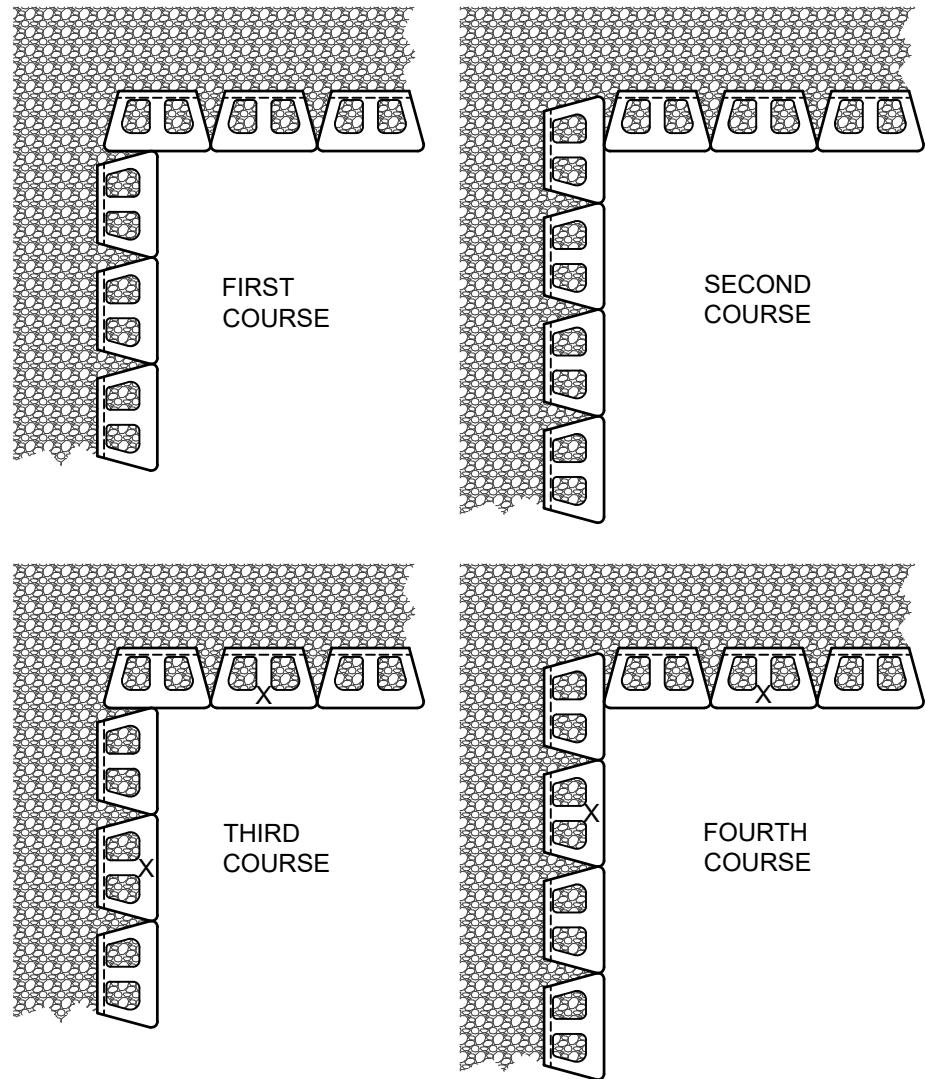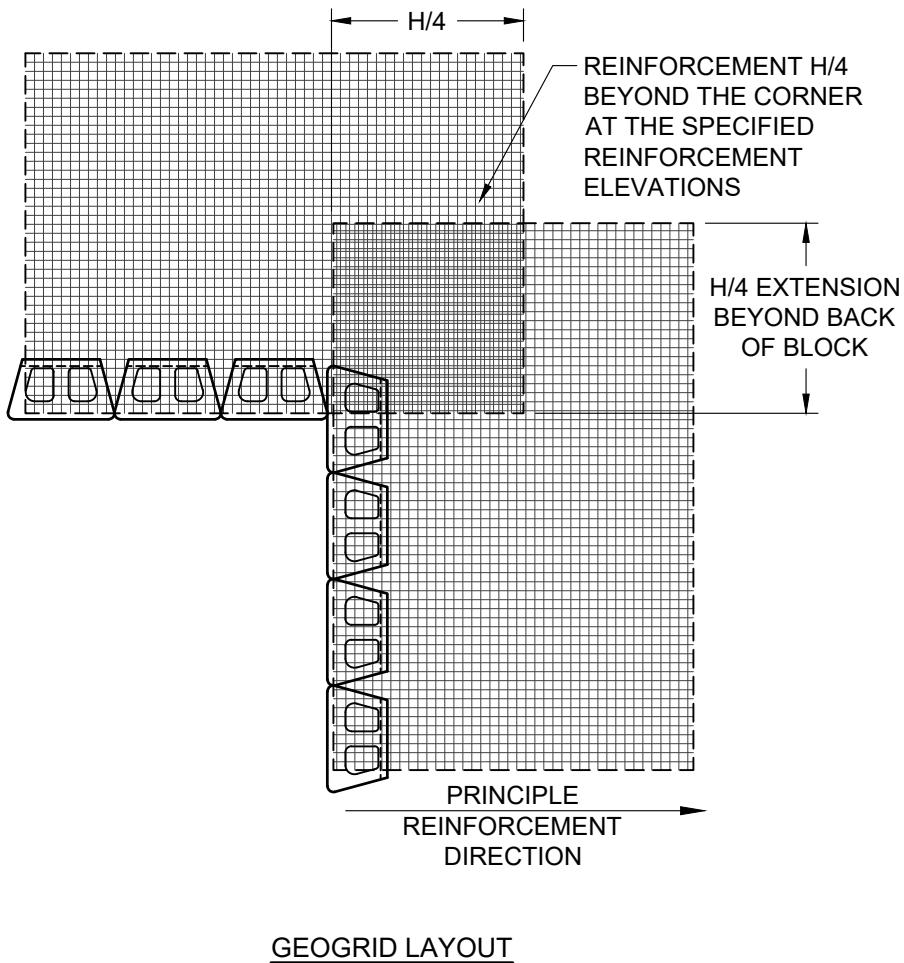


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**Diamond® 10D Retaining Wall System**  
**TYPICAL DETAIL INSIDE CORNERS**


Scale: 3/8" = 1'-0"	Drawn by: MAH
Date: 10/29/2025	Drawing number: D10D-30



COURSE A

NOTES:

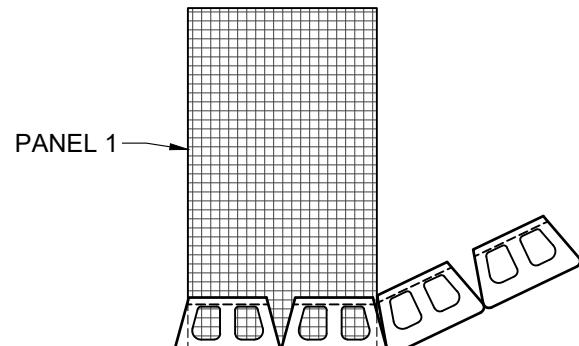1. ALTERNATE COURSES "A" & "B" AS NEEDED TO FULL HEIGHT OF WALL.
2. MODIFY UNITS AS NEEDED TO MAINTAIN RUNNING BOND.
3. ADHERE ALL PARTIAL UNITS WITH CONSTRUCTION GRADE ADHESIVE.
4. ADJUST PLACEMENT IN FIELD TO ACHIEVE DESIRED ANGLE.
5. FREE-DRAINING AGGREGATE (NOT SHOWN) TO SPAN 10 FT. ALONG THE WALL FACE AND TO THE BACK OF THE REINFORCED ZONE.

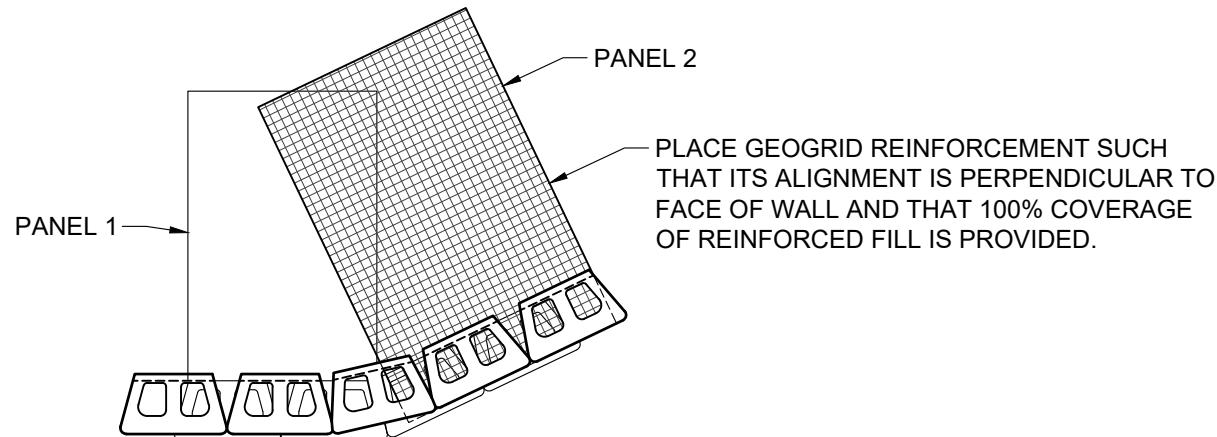

COURSE B

PLACE GEOGRID REINFORCEMENT SUCH THAT ITS ALIGNMENT IS PERPENDICULAR TO FACE OF WALL AND THAT 100% COVERAGE OF REINFORCED FILL IS PROVIDED.





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**Diamond® 10D Retaining Wall System**  
**TYPICAL DETAIL OUTSIDE ANGLED CORNERS**

Scale: 3/8" = 1'-0"	Drawn by: MAH
Date: 10/29/2025	Drawing number: D10D-31



NOTE: FREE-DRAINING AGGREGATE (NOT SHOWN) TO SPAN 10 FT. ALONG THE WALL FACE AND TO THE BACK OF THE REINFORCED ZONE

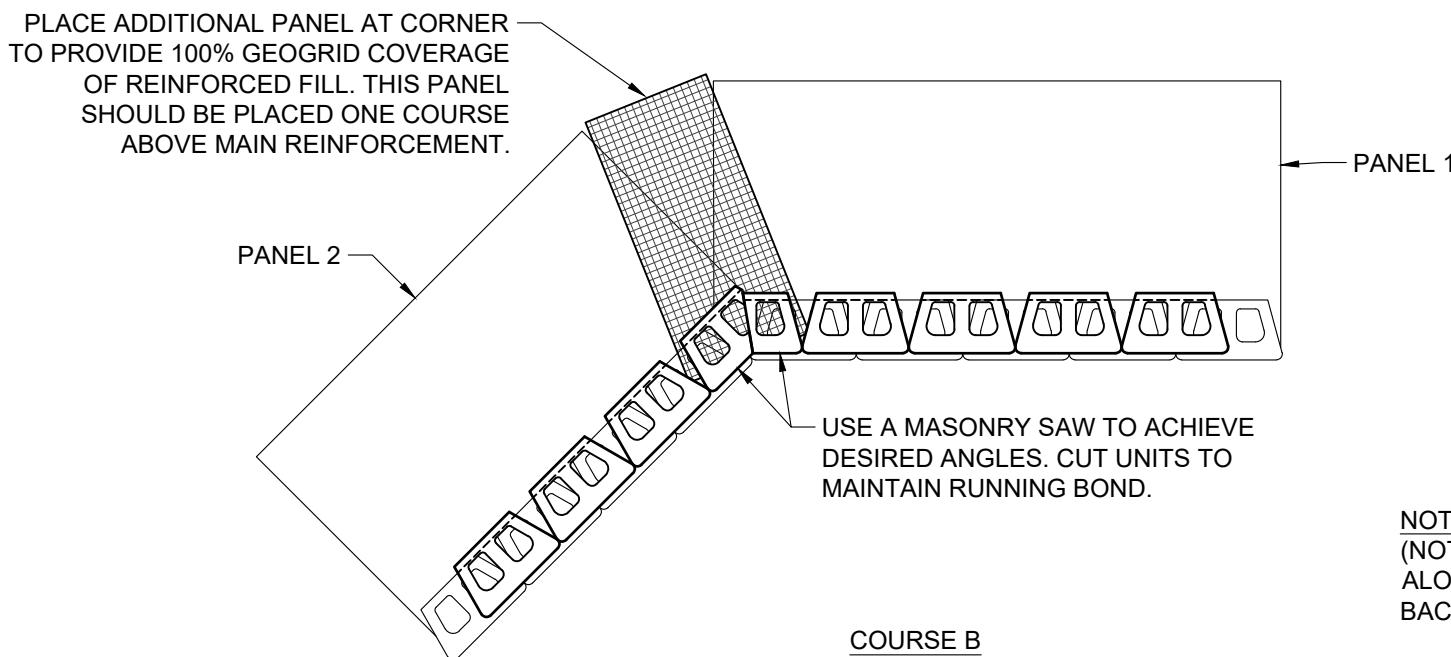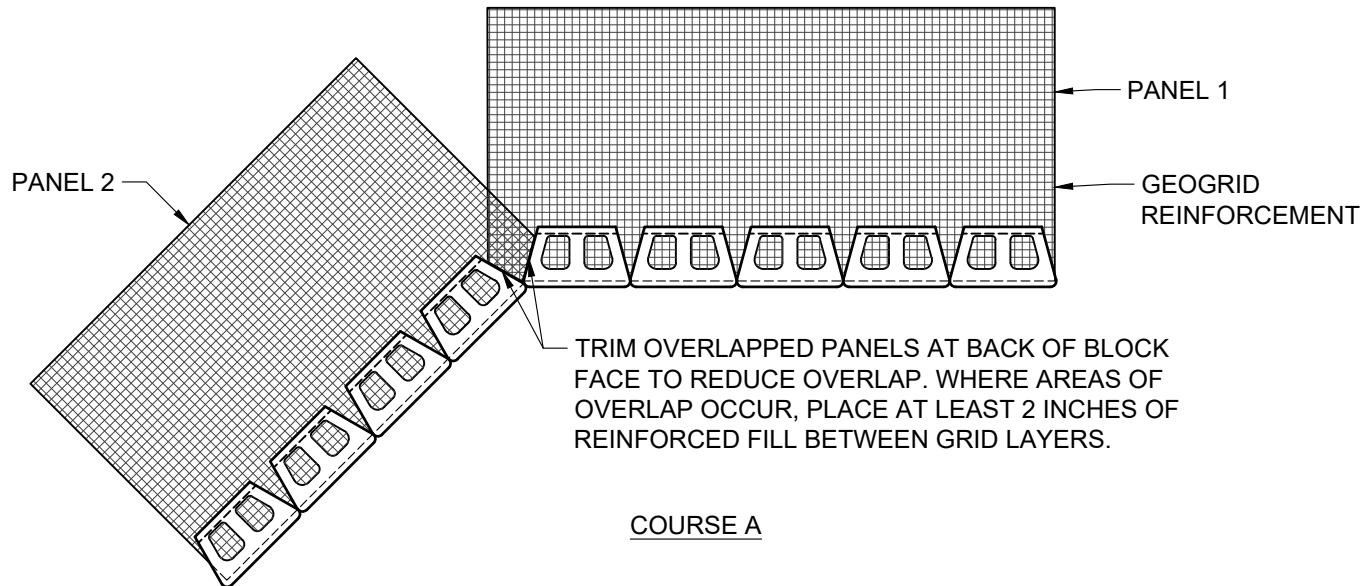

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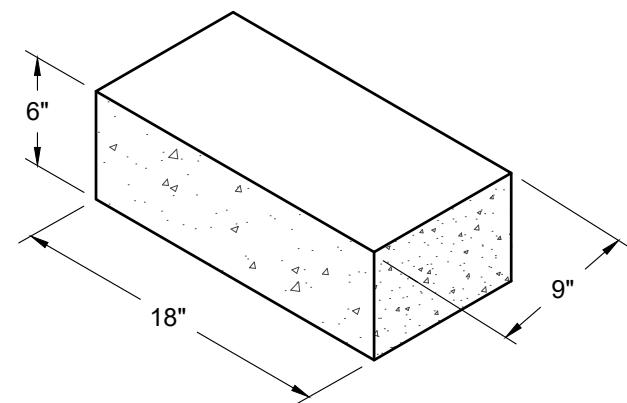
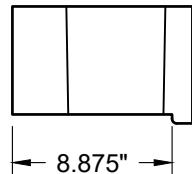
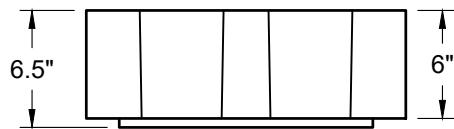
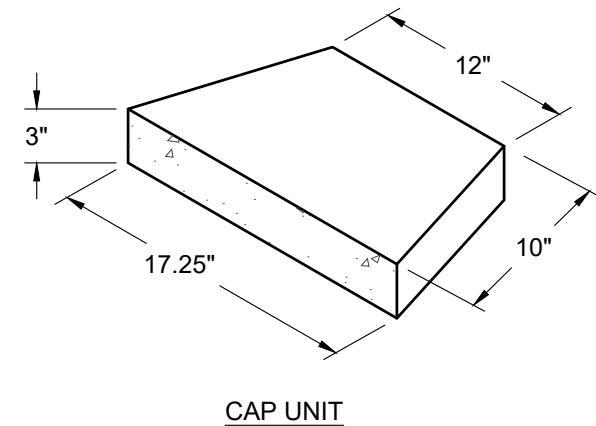
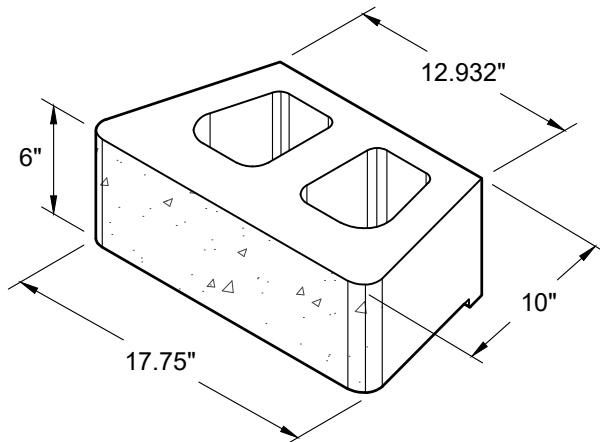
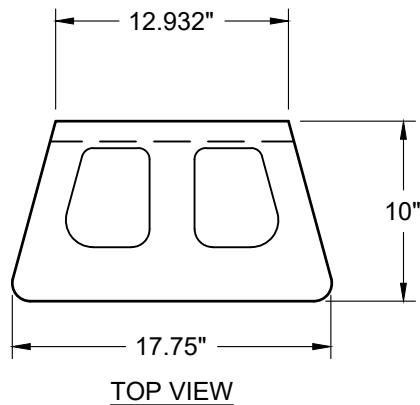
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## Diamond® 10D Retaining Wall System

### TYPICAL DETAIL INSIDE ANGLED CORNERS

Scale: 3/8" = 1'-0"	Drawn by: MAH
Date: 10/29/2025	Drawing number: D10D-32



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## Diamond® 10D Retaining Wall System

### INDIVIDUAL BLOCK DETAILS - STRAIGHT FACE

Scale: NONE	Drawn by: MAH
Date: 10/29/2025	Drawing number: D10D-34